
CITY OF PORTSMOUTH, NEW HAMPSHIRE

PEIRCE ISLAND FORCE MAIN AND WATER MAIN REPLACEMENT AUGUST 2021 BID NUMBER #35-21

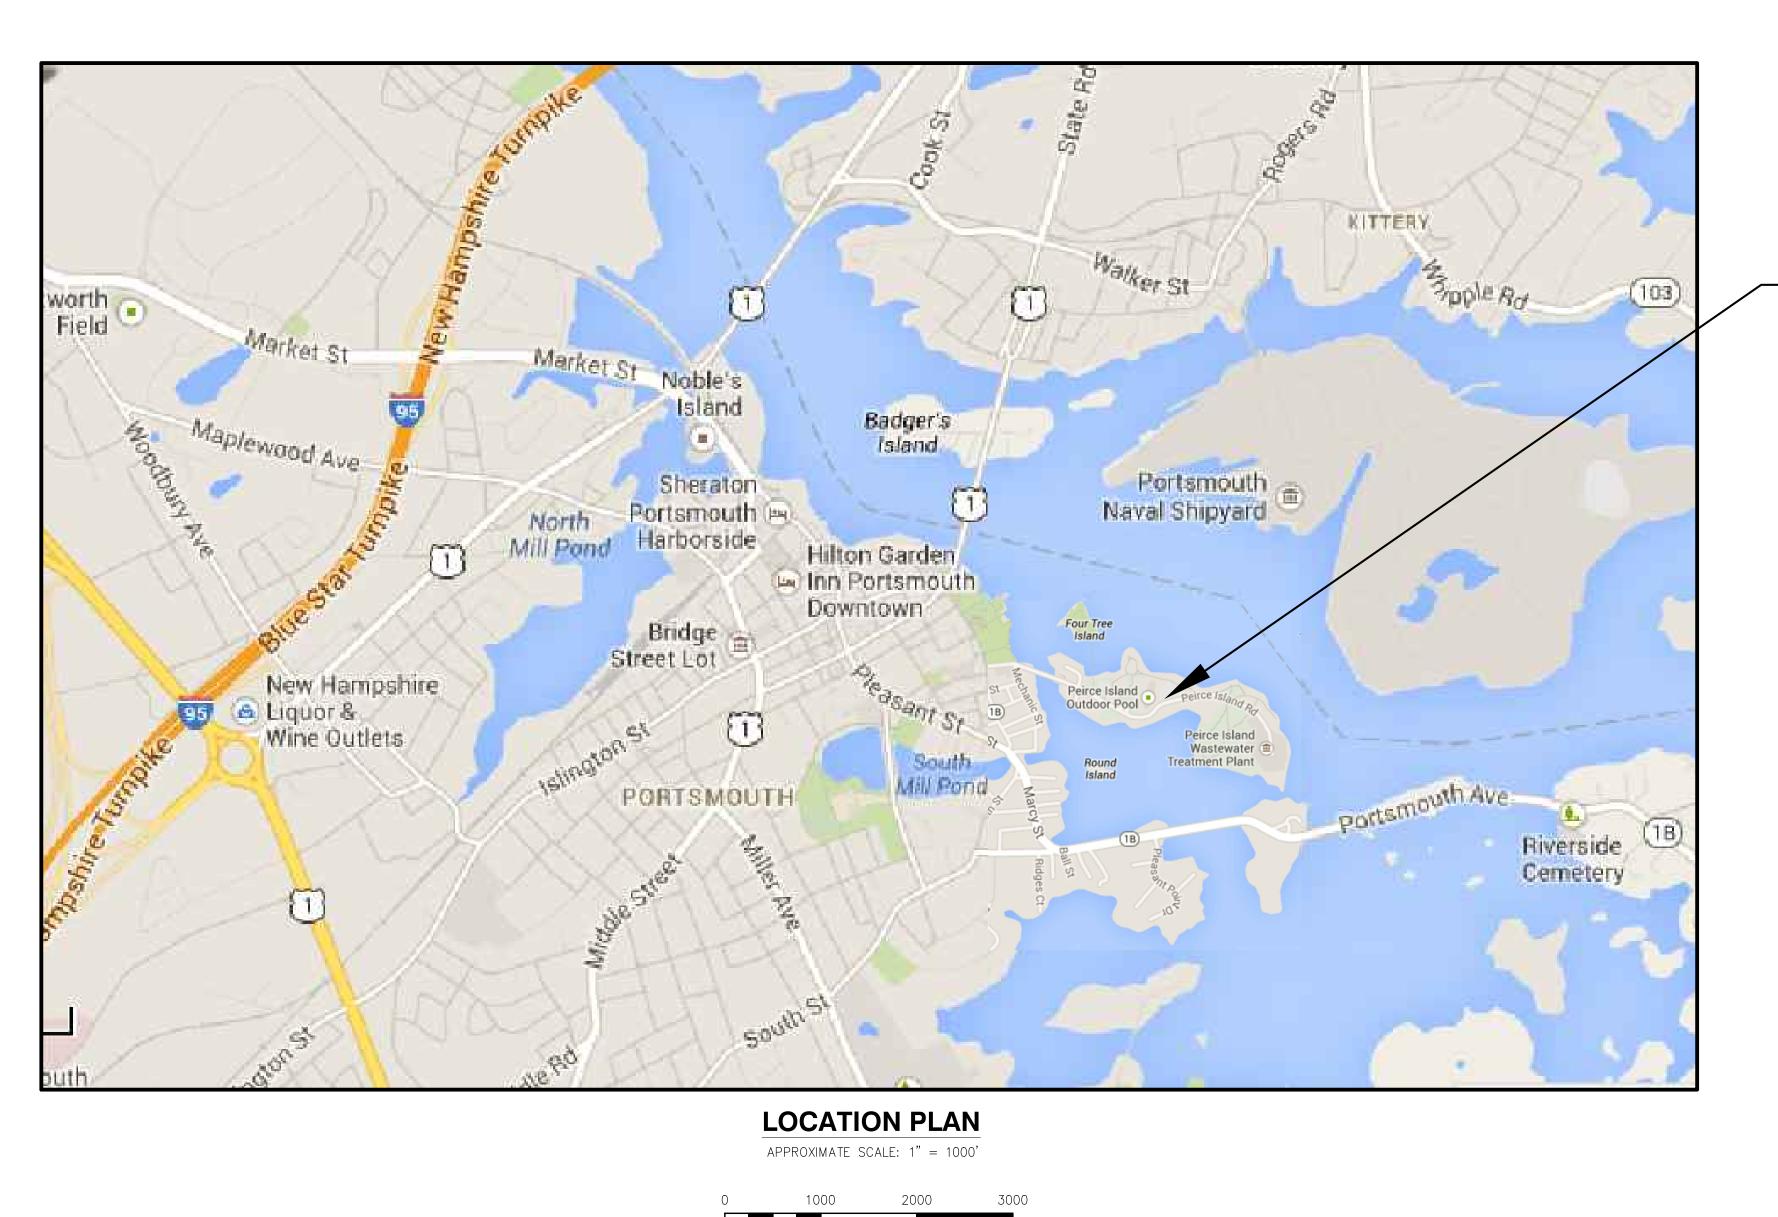

SCALE: 1"=1000'

PROJECT LOCATION

INDEX OF DRAWINGS

SHEET NO. TITLE

GENERAL

00 G-001 COVER SHEET, LOCATION PLAN AND INDEX OF DRAWINGS
00 G-002 OVERALL SITE AND KEY PLAN

LEGEND, ABBREVIATIONS AND GENERAL NOTES

CIVIL

00 C-001

00 C-101 EXISTING CONDITIONS, EROSION CONTROL AND DEMOLITION PLAN I
00 C-102 EXISTING CONDITIONS, EROSION CONTROL AND DEMOLITION PLAN II
00 C-103 EXISTING CONDITIONS, EROSION CONTROL AND DEMOLITION PLAN III
00 C-104 CONTRACTOR ACCESS AND STAGING AREA AND SITE RESTORATION PLAN
00 C-105 PIPING PLAN AND PROFILE II

00 C-107 PIPING PLAN AND PROFILE III
00 C-108 ENLARGED PLANS I
00 C-109 ENLARGED PLANS II

00 C-110 PIPING PLAN AND PROFILE PEIRCE ISLAND BRIDGE SLIPLINING 99 C-501 DETAILS I

99 C-502 DETAILS II
99 C-503 DETAILS III
99 C-504 DETAILS IV
99 C-505 DETAILS V

TRAFFIC MANAGEMENT

00T-001TRAFFIC MANAGEMENT PLAN I00T-002TRAFFIC MANAGEMENT PLAN II00T-003TRAFFIC MANAGEMENT PLAN III

AECOM

PROJE

PEIRCE ISLAND
FORCE MAIN AND
WATER MAIN
REPLACEMENT
Peirce Island, Portsmouth NH

OWNE

CITY OF PORTSMOUTH NEW HAMPSHIRE

680 Peverly Hill Road Portsmouth, NH 03801

ENGINEER

AECOM TECHNICAL SERVICES, INC. 250 APOLLO DRIVE CHELMSFORD, MA 01824 PHONE: (978) 905-2100 www.aecom.com

REGISTRATION



ISSUE/REVISION

I/R	DATE	DESCRIPTION

PROJECT NUMBER

60649477

Designed By:	S. HE
Drawn By:	M. THIBODEAU
Dept Check:	C. BENZIGER
Proj Check:	E. MESERVE
Date:	AUGUST 2021
Scale:	AS NOTED


DISCIPLINE

CIVIL SHEET TITLE

COVER SHEET, LOCATION
PLAN AND INDEX OF
DRAWINGS
SHEET NUMBER

00 G-001

NWE: L: \LEGACY\USCHLIFPOO1\DATA\PROJECTS\WAKEFIELD\DATA_2\EVERYONE\PORTSMOUTH PEIRCE ISLAND FM REPLACEMENT\900 CAD—GIS\SHEETS\G\00 G—001.DW E: Tuesday, August 17, 2021 11:<u>1</u>5:51 AM B

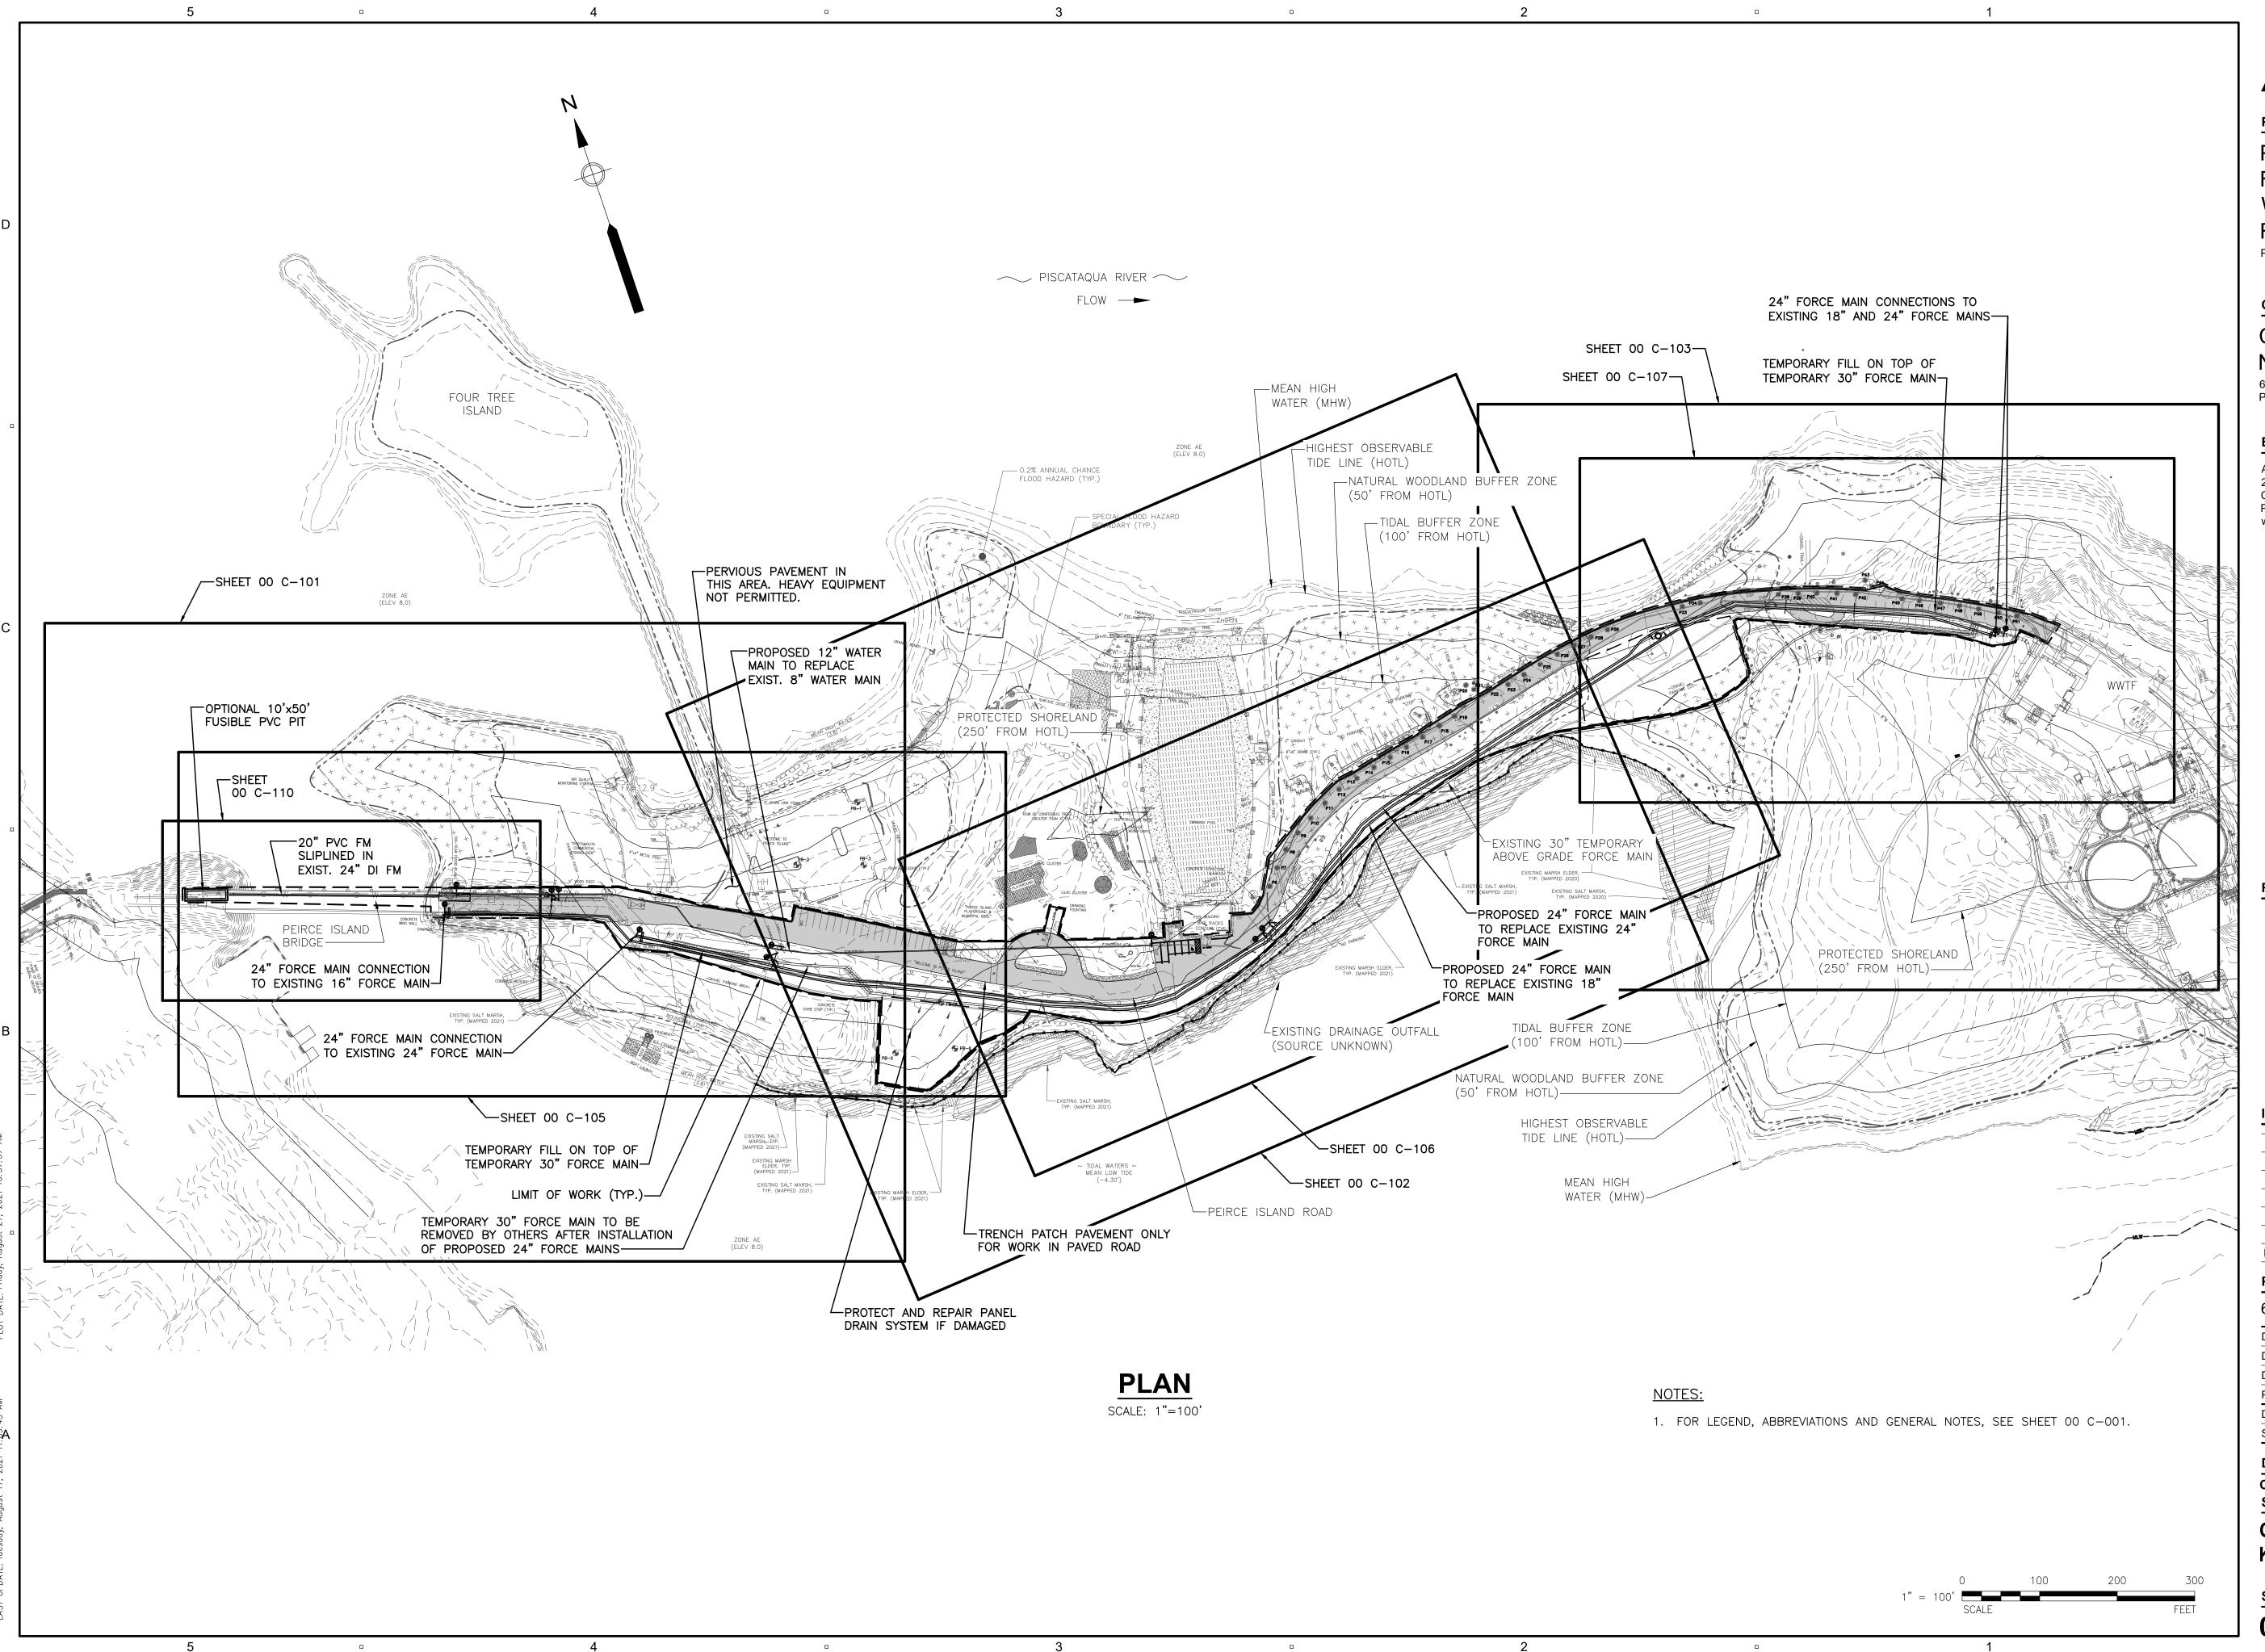

PROJECT

PEIRCE ISLAND
FORCE MAIN AND
WATER MAIN
REPLACEMENT
Peirce Island, Portsmouth NH

OWNER

CITY OF PORTSMOUTH NEW HAMPSHIRE

680 Peverly Hill Road Portsmouth, NH 03801

ENGINEER

AECOM TECHNICAL SERVICES, INC. 250 APOLLO DRIVE CHELMSFORD, MA 01824 PHONE: (978) 905-2100 www.aecom.com

REGISTRATION



ISSUE/REVISION

I/R	DATE	DESCRIPTION

PROJECT NUMBER

60649477

Designed By:	S. HE
Drawn By:	M. THIBODEAU
Dept Check:	C. BENZIGER
Proj Check:	E. MESERVE
Date:	AUGUST 2021
Scale:	AS NOTED

DISCIPLINE

CIVIL SHEET TITLE

OVERALL SITE AND KEY PLAN

SHEET NUMBER

00 G-002

- 2. HORIZONTAL LOCATIONS SHOWN ARE REFERENCED TO THE NH STATE PLANE COORDINATE SYSTEM, NAD83.
- 3. VERTICAL DATUM IS NAVD 88 AND IS BASED ON NATIONAL GEODETIC SURVEY FIRST ORDER CLASS I BENCHMARKS "V31 USGS" (PID:OCO289) HAVING A PUBLISHED ELEVATION OF 29.19' AND "W31" (PID:OCO413) HAVING A PUBLISHED ELEVATION OF 20.54'. REFER ALSO TO VERTICAL DATUM CONVERSION NOTE BELOW.
- 4. TOPOGRAPHIC INFORMATION SHOWN IS THE RESULT OF A SURVEY MADE IN JULY 2013, AUGUST 2020 AND JANUARY 2021 BY DOUCET SURVEY, INC., 102 KENT PLACE, NEWMARKET, NH 03857. WETLAND BOUNDARIES, HIGHEST OBSERVABLE TIDE LINE (HOTL) AND EXISTING TREE SURVEY WERE DELINEATED BY NORMANDEAU ASSOCIATES, INC. ON JANUARY 14, 2021.
- 5. THE LOCATION OF ANY UNDERGROUND UTILITY INFORMATION SHOWN ON THIS PLAN IS BASED ON RECORD DRAWINGS AND IS APPROXIMATE. THE OWNER DOES NOT GUARANTEE THE ACCURACY OR COMPLETENESS OF UNDERGROUND UTILITIES SHOWN. PRIOR TO ANY EXCAVATION ON SITE THE CONTRACTOR SHALL CONTACT DIG SAFE AT 1-888-344-7233.
- 6. IT IS THE CONTRACTOR'S RESPONSIBILITY TO VERIFY ALL EXISTING CONDITIONS AT THE SITE.
- 7. THE CONTRACTOR SHALL ERECT EROSION CONTROL MEASURES PRIOR TO COMMENCING ANY CLEARING, EXCAVATION OR STORAGE OF BACKFILL MATERIAL ON-SITE. REFER TO SPECIFICATION SECTION 01568 AND DETAILS.
- 8. THE ENGINEER MAY DIRECT THE CONTRACTOR TO VARY THE PROPOSED WORK DURING CONSTRUCTION TO MEET EXISTING CONDITIONS.
- 9. THE CONTRACTOR SHALL TAKE ALL NECESSARY MEASURES AND SHALL PROVIDE ALL NECESSARY CONTINUOUS BARRIERS OF SUFFICIENT TYPE. SIZE AND STRENGTH TO PREVENT ACCESS TO ALL OPEN EXCAVATIONS AT THE
- 10. INTERRUPTION TO WATER AND OTHER EXISTING UTILITIES SHALL BE REQUESTED IN WRITING BY THE CONTRACTOR 3 DAYS IN ADVANCE OF THE WORK AND REVIEWED BY THE ENGINEER.

COMPLETION OF EACH DAYS WORK. REFER TO SPECIFICATION SECTION 01046 FOR ADDITIONAL REQUIREMENTS

- 11. CONTRACTOR SHALL MAINTAIN FLOW OF SEWAGE IN ACCORDANCE WITH SECTION 01063.
- 12. EXISTING UTILITIES INTERFERING WITH THE WORK SHALL BE RELOCATED AS DIRECTED BY THE ENGINEER AT NO. ADDITIONAL COST TO THE OWNER.
- 13. PIPE SHALL BE AS INDICATED IN THE PIPING SCHEDULE AND SPECIFICATIONS. PROVIDE RESTRAINED MECHANICAL JOINT FITTINGS FOR CONNECTIONS TO EXISTING PIPING AS SPECIFIED
- 14. PIPING WHICH IS EXPOSED DURING EXCAVATION, INCLUDING TEE'S, VALVES, AND FITTINGS, AND IS NOT TO BE DEMOLISHED, SHALL BE SUPPORTED, BRACED OR OTHERWISE PROTECTED DURING CONSTRUCTION ACTIVITIES.
- 15. ALL PIPING SHALL BE CONSTRUCTED WITH A MINIMUM OF 5 FEET OF COVER.
- 16. ALL PIPES SHALL SLOPE UNIFORMLY BETWEEN ELEVATIONS SHOWN UNLESS OTHERWISE INDICATED ON THE DRAWINGS OR DIRECTED BY THE ENGINEER. NO SAGS OR CRESTS IN PIPING WILL BE PERMITTED.
- 17. WHERE NEW PIPING IS TO BE CONNECTED TO EXISTING PIPING, THE CONTRACTOR SHALL FURNISH AND INSTALL ALL ADAPTERS, FITTINGS, AND ADDITIONAL PIPE WHICH MAY NOT BE SHOWN IN DETAILS (REQUIRED AS A RESULT OF CUTTING THE EXISTING PIPE BACK) IN ORDER TO COMPLETE THE CONNECTION AS REQUIRED.
- 18. ALL SIGNAGE, HEADWALLS, GUARD RAILS, GUARD POSTS, FENCES, CURBS, ROADWAYS, SIDEWALKS AND ANY OTHER OBJECTS DISTURBED BY CONTRACTOR ACTIVITIES SHALL BE RETURNED TO PRE-CONSTRUCTION CONDITION OR BETTER AS DIRECTED BY THE ENGINEER AT NO ADDITIONAL COST TO THE OWNER.
- 19. ALL AREAS OF EXCAVATION, BACKFILL, FILL AND GRADING SHALL BE RETURNED TO THE ORIGINAL GRADE
- 20. ALL UTILITY BOXES, FRAMES, GRATES, ETC. DISTURBED BY CONTRACTOR AND NOT TO BE ABANDONED SHALL BE RESET TO THE PROPER GRADE AT NO ADDITIONAL COST TO THE OWNER.
- 21. UNPAVED AREAS DISTURBED BY THE CONTRACTOR SHALL BE CLEARED AND GRUBBED IF REQUIRED, AND RESTORED WITH LOAM AND SEED. SEEDED AREAS SHALL BE PROTECTED BY SNOW FENCING UNTIL APPROVED TO
- 22. ALL EXISTING PIPES TO BE ABANDONED SHALL BE PLUGGED AT OPEN ENDS. SEE PIPE PLUGGING DETAIL ON
- 23. RECORD DRAWINGS FOR EXISTING FACILITIES CAN BE FOUND IN THE SPECIFICATIONS.
- 24. PROVIDE AND MAINTAIN ORANGE CONSTRUCTION FENCING ABOVE SALT MARSH AND MARSH ELDER AS NEEDED.

VERTICAL DATUM CONVERSION NOTE:

UNLESS SHOWN ON THE DRAWINGS.

SURVEY BY DOUCET ASSOCIATES IS BASED ON NAVD 88 DATUM. EXISTING PLANT AND FORCE MAIN RECORD DRAWINGS ARE BASED ON NGVD 29 DATUM. TO CONVERT NAVD 88 ELEVATIONS TO NGVD 29, ADD 0.77 FEET. TO CONVERT NGVD ELEVATIONS TO NAVD 88 SUBTRACT 0.77 FEET.

CONCRETE NOTES:

- 1. CONCRETE WORK SHALL CONFORM TO THE STANDARD SPECIFICATIONS FOR STRUCTURAL CONCRETE (ACI 301) AND THE CODE REQUIREMENTS FOR ENVIRONMENTAL ENGINEERING CONCRETE STRUCTURES (ACI 350) AND
- 2. USE NORMAL WEIGHT CAST-IN-PLACE CONCRETE WITH ASTM C 150, TYPE II CEMENT FOR ALL CONCRETE WORK.
- 3. PROVIDE CONCRETE HAVING A 28-DAY COMPRESSIVE STRENGTH OF 4,000 PSI AND A MAXIMUM WATER-CEMENT RATIO OF 0.45 UNLESS OTHERWISE INDICATED OR SPECIFIED.
- 4. AIR-ENTRAIN ALL CONCRETE.
- 5. WELDED WIRE FABRIC SHALL CONFORM TO ASTM A 1064. PROVIDE WELDED WIRE FABRIC IN FLAT SHEETS. STAGGER SPLICES AND LAP AT LEAST TWO FULL MESHES.
- 6. WAIT A MINIMUM OF 72 HOURS BEFORE PLACING ADJACENT CONCRETE SECTIONS.
- 7. PROVIDE CONSTRUCTION AND EXPANSION JOINTS WHERE INDICATED. DO NOT OMIT OR ADD JOINTS.
- 8. PROVIDE 3/4-INCH CHAMFER ON ALL EXPOSED CORNERS OF CONCRETE ELEMENTS.
- 9. BROOM FINISH EXTERIOR CONCRETE SLABS UNLESS OTHERWISE INDICATED OR AS SPECIFIED.

GEOTECHNICAL NOTES

- 1. FOR EARTH EXCAVATION, BACKFILL, FILL AND GRADING SEE SPECIFICATION 02210.
- 2. FOR DEWATERING SEE SPECIFICATION 02140.
- 3. FOR EXCAVATION SUPPORT SYSTEM SEE SPECIFICATION 02160.
- 4. BORING LOCATIONS ARE SHOWN ON THE PLANS AND BORING LOGS ARE BOUND IN THE SPECIFICATIONS.
- 5. BORINGS WERE TAKEN FOR PURPOSES OF DESIGN AND INDICATE SUBSURFACE CONDITIONS AT BORING LOCATION ONLY. SUBSURFACE CONDITIONS MAY VARY FROM THOSE SHOWN IN THE LOG.
- 6. IN ALL AREAS WHERE DEWATERING IS NECESSARY, MEASURES SHALL BE TAKEN TO ENSURE THE PRESERVATION OF WATERCOURSES AND COMPLIANCE WITH ALL REGULATIONS AND LAWS, ALL DEWATERING MUST BE DISCHARGED INTO SEDIMENT TRAPS AS INDICATED IN THE DETAILS AND AS SPECIFIED IN SPECIFICATION SECTION 01568.

TEMPORARY BENCHMARK

TAPPING SLEEVE AND VALVE

UNDERGROUND ELECTRIC

VERTICAL GRANITE CURB

WATER SHUT OFF

WATER VALVE

TEST PIT

TYPICAL

VENT

VERTICAL

7. FOR ROCK EXCAVATION AND DISPOSAL, SEE SPECIFICATION SECTION 02211.

	<u>ABBREVIATIO</u>	NS_
APPROX.	APPROXIMATE	TBM
B&B	BALL AND BURLAP	TP
BLDG.	BUILDING	TS&V
СВ	CATCH BASIN	TYP.
CONC.	CONCRETE	UE
C.I.	CAST IRON	V
CLF	CHAIN LINK FENCE	VERT.
C.O. OR CO	CLEANOUT	VGC
CW	CITY WATER OR CROSS WALK	WSO
D	DRAIN	WV
DI	DUCTILE IRON	
DIA.	DIAMETER	
DIM.	DIMENSION	
DMH	DRAIN MANHOLE	
DWGS	DRAWINGS	
DYL OR DYCL	DOUBLE YELLOW CENTER LINE	
E E	ELECTRICAL	
ECC.	ECCENTRIC	
EL. OR ELEV.	ELEVATION	
EMERG.	EMERGENCY	
EOP	EDGE OF PAVEMENT	
EXIST.	EXISTING	
FES	FLARED END SECTION	
FF OR F.F.E.		
FM	FORCE MAIN	
FPVC	FUSIBLE PVC	
GAL.	GALLON	
GL	GLASS LINED	
GP	GUARD POST	
GRAN.	GRANITE	
GV	GATE VALVE	
HOTL	HIGHEST OBSERVABLE TIDE LINE	
INV.	INVERT	
LF	LINEAR FOOT	
L.O.W.	LIMIT OF WORK	
MECH.	MECHANICAL	
МН	MANHOLE	
MHW	MEAN HIGH WATER	
MLW	MEAN LOW WATER	
MJ	MECHANICAL JOINT	
MSL	MEAN SEA LEVEL	
N.C.	NORMALLY CLOSED	
PBS	PRINTED BOTH SIDES	
PSNH	PUBLIC SERVICE OF NEW HAMPSHIRE	
PVC	POLYVINYL CHLORIDE	
RCP	REINFORCED CONCRETE PIPE	
RED.	REDUCER	
RET.	RETAIN OR RETAINING	
SAN	SANITARY DRAIN	
SD	STORM DRAIN	
SL	SLUDGE OR STOP LINE	
SMH	SEWER MANHOLE	

SINGLE WHITE LINE

SINGLE YELLOW LINE

SWL

SYL

LEGEND

DILLITY POLE & GUY WIRE UTILITY POLE & GUY WIRE SIGN YAND HYDRANT WOODEN POST THE INDRANT WATER WITER WATER CATE VALVE WATER SHUTOFF VALVE CLEAROUT TRAFFIC DIRECTION ARROW ELECTR GOX CATCH BASIN (ROUND) DEAN MANHOLE WATER VANHOLE WATER VANHOLE WATER VANHOLE WATER WATER WITER WHITE SHUTOFF VALVE CATCH BASIN (ROUND) CATCH BAS
SIGN STRUCTURE WATE INFORMAT WOODEN POST FIRE PYDRANT WATER METER WATER GATE VALVE WATER GATE VALVE WATER SHITTOFF VALVE CLEANOUT TRAFTIC DIRECTION ARROW If ELECTRIC BOX CATCH BASIN ORAN MAN-FOLE CLEANOUT CHEMICAL MANHOLE CHEMICAL MANHOLE WATER WANHOLE WATER WANHOLE WATER WANHOLE UNDENTIFIED MANHOLE WATER WANHOLE WATER WATER WATER WATER WATER WATER WATER WATER WATER WATER WATER WATER WATER WATER
WARD HYDRANT WOODEN POST THE HYDRANT THE HORANT WATER MATER WATER MATER WATER SALE VALVE WATER SHUTOFF VALVE CLEANOUT TREE REMOVAL
PIPE OR CAP ### WOODEN POST ### FEE HODBANT WATER METER WATER CATE VA VE ### WATER CATE VA VE ### WATER SHUTOFF VALVE CLEANOUT ### CATCH BASIN (ROUND) ### CHEMICAL MANHOLE ### CATCH WALVE
WATER METER WATER SATE VALVE WATER SHOTOFF VALVE CLEANOUT TRAFFIC DIRECTION ARROW THE CLECTRIC BASIN (ROUND) CATCH BASIN (ROUND) CATCH BASIN (ROUND) CATCH BASIN DANN MANFOLE CHEMICAL MANHOLE WATER SHOULD MANHOLE
WATER SATE YALVE WATER SILPTOFT VALVE CLEANOUT TRAFFIC DIRECTION ARROW TEE CLECTRIC BOX CATCH BASIN (ROUND) CATCH BASIN (ROUND) CATCH BASIN DEAN MANHOLE CHEMICAL MANHOLE WATER
ABADON IN PLACE ## WATER SHUTOFF WALVE CLEANOUT TRAFFIC DIRECTION ARROW TEE
WATER SHUTOFF VALVE CLEANOUT TRAFFIC DIRECTION ARROW E ELECTRIC BOX CATCH BASIN (ROUND) CATCH BASIN (ROUND) CATCH BASIN DRAIN MANHOLE CHEMICAL MANHOLE CHEMICAL MANHOLE CHEMICAL MANHOLE CHEMICAL MANHOLE CONTENUOUS TREE CONTEROUS TREE CONTEROUS TREE CONCRETE BOULDER BOULDER CONCRETE CONCRET
CLEANOUT TRAFFIC DIRECTION ARROW E ELECTRIC BOX CATCH BASIN (ROUND) DRAIN MANHOLE CHEMICAL MANHOLE WATER MANHOLE UNDENTIFIED MANHOLE UNDENTIFIED MANHOLE UNDENTIFIED MANHOLE FLAG POLE CONTINUENCY TREE WATER MANHOLE SHRUB CONTINUENCY CRUSHED STICNE MOWING STRP
TRAFFIC DIRECTION ARROW E ELECTRIC BOX CATCH BASIN (ROUND) CATCH BASIN DRAIN MANHOLE ELECTRIC MANHOLE CHEMICAL MANHOLE WATER MANHOLE WATER MANHOLE UNIDENTIFIED MANHOLE JURISDICTIONAL WETLAND SYMBOL FLAC POLE COMFERGUS TREE CONCRETE BOULDER CONCRETE BOULDER CONCRETE BOULDER CONCRETE BOULDER CRAWLE CHAIN LINK FENCE CHAIN LINK FENCE CONTROL CONTRO
ELECTRIC BOX CATCH BASIN (ROUND) CATCH BASIN DERAIN MANHOLE CHEMICAL MANHOLE WATER MANHOLE WATER MANHOLE WINDENTFIED MANHOLE UNIDENTFIED MANHOLE FLAG POLE CONFEROUS TREE CONFEROUS TREE BOULDER SHRUB CONCRETE BOULDER CONCRETE BOULDER CONCRETE BOULDER CONCRETE BOULDER CONCRETE CONCRETE BOULDER CONCRETE CONCRET
CATCH BASIN (ROUND) CATCH BASIN DRAIN MANHOLE ELECTRIC MANHOLE OCHEMICAL MANHOLE WATER MANHOLE UNIDENTIFIED WANHOLE JURISDICTIONAL WETLAND SYMBOL FLAG POLE CONIFEROUS TREE DECIDUUS TREE BOULDER CONCRETE BOULDER CONCRETE BOULDER CONCRETE BOULDER CONCRETE BOULDER CATCH BASIN CLEANOUT CONCRETE BOULDER CONCRETE BOULDER CONCRETE BOULDER CARABLE LANDSCAPED AREA GRAVEL LEDGE OUTCROP BOLLARD DRAINLINK FENCE CHW COVERHEAD WIRES CHAIN LINK FENCE CONTOUR TREE LINE SHOULDER CONTOUR CONTOUR CONTOUR CONTOUR CONTOUR CONTOUR CRUSHED STONE MOWING STRIP CRUSHED STONE MOWING STRIP
□ CATCH BASIN □ DRAIN MANHOLE □ ELECTRIC MANHOLE □ CHEMICAL MANHOLE □ WATER MANHOLE □ WATER MANHOLE □ UNIDENTIFIED MANHOLE □ UNIDENTIFIE
© DRAIN MANHOLE © ELECTRIC MANHOLE © CHEMICAL MANHOLE © WATER MANHOLE © WATER MANHOLE © WATER MANHOLE © WATER MANHOLE © UNIDENTIFIED MANHOLE □ JURISDICTIONAL WETLAND SYMBOL □ FLAG POLE □ CONIFEROUS TREE □ DECIDUOUS TREE □ DECI
C CHEMICAL MANHOLE WATER MANHOLE WATER MANHOLE UNIDENTIFIED MANHOLE JURISDICTIONAL WETLAND SYMBOL FLAG POLE CONFEROUS TREE DECIDUOUS TREE SHRUB CONCRETE BOULDER CONCRETE BOULDERS LANDSCAPED AREA GRAVEL LEGGE OUTCROP DECIDION OF BOULDERS LEGGE OUTCROP OBOLLARD DRAINAGE FLOW DIRECTION ARROW CHAINLINK FENCE X X CHAINLINK FENCE CHAINLINK FENCE CHAINLINK FENCE CHAINLINK FENCE CHAINLINK FENCE CHAINLINK FENCE TEMPORARY FENCE CONTOUR X CHAINLINK FENCE CONTOUR Z CONTOUR SHRUB LINE GUARD POST OR BOLLARD TEMPORARY FENCE CHAINLINK FENCE CONTOUR Z CHAINLINK FENCE CONTOUR CONTOUR CONTOUR CONTOUR CONTOUR CRUSHED STONE MOWING STRIP CRUSHED STONE MOWING STRIP
WATER MANHOLE SEWER MANHOLE UNIDENTIFIED MANHOLE UNIDENTIFIED MANHOLE UNIDENTIFIED MANHOLE UNIDENTIFIED MANHOLE UNIDENTIFIED MANHOLE UNIDENTIFIED MANHOLE PIPE - > 6" DIAM. PI
S SEWER MANHOLE UNIDENTIFIED MANHOLE JURISDICTIONAL WETLAND SYMBOL FLAG POLE CONIFEROUS TREE DECIDUOUS TREE SHRUB CONCRETE BOULDER ROW OF BOULDERS LANDSCAPED AREA GRAVEL LEDGE OUTCROP BOLLARD DRAINAGE FLOW DIRECTION ARROW CHAIN LINK FENCE CHAIN LINK FENCE CHAIN LINK FENCE CHAIN LINK FENCE CHAINLINK FENCE CONTOUR STRAW BALE EROSION CONTROL X 23.50 SHRUB LINE SHRUB CONTOUR 23 CONTOUR 23 CONTOUR 23 CONTOUR CRUSHED STONE MOWING STRIP
UNIDENTIFIED MANHOLE JURISDICTIONAL WETLAND SYMBOL FLAG POLE CONFEROUS TREE DECIDUOUS TREE SHRUB CONCRETE BOULDER ROW OF BOULDERS LANDSCAPED AREA GRAVEL LEDGE OUTCROP BOLLARD DRAINAGE FLOW DIRECTION ARROW CHAINLINK FENCE OHW OHW OHW OHW OHW CONCRETE SHRUB CLEANOUT C.O. CHAIN LINK FENCE CHAIN LINK FENCE CHAIN LINK FENCE CONTOUR CHAINLINK FENCE CONTOUR CONTOUR CONTOUR CONTOUR CONTOUR CONTOUR CONTOUR CRUSHED STONE MOWING STRIP
JURISDICTIONAL WETLAND SYMBOL FLAG POLE CONIFEROUS TREE DECIDUOUS TREE SHRUB CONCRETE BOULDER ROW OF BOULDERS LANDSCAPED AREA GRAVEL LEDGE OUTCROP DRAINAGE FLOW DIRECTION ARROW CHAINLINK FENCE CHAINLINK FENCE TEMPORARY FENCE TEMPORARY FENCE OHW OVERHEAD WIRES CONTOUR 23 CHAINLINE SILT FENCE AND STRAW BALE EROSION CONTROL CHAINLINK FENCE CONTOUR 23 CONTOUR 23 CONTOUR CRUSHED STONE MOWING STRIP
CONIFEROUS TREE DECIDUOUS TREE SHRUB CONCRETE BOULDER ROW OF BOULDERS LANDSCAPED AREA GRAVEL LEDGE OUTCROP BOLLARD DRAINAGE FLOW DIRECTION ARROW TREE LINE OVERHEAD WIRES DRAIN LINE TREE LINE SHOULDER CONTOUR TREE LINE SPOT ELEVATION CONTOUR LINE CRUSHED STONE MOWING STRIP MANHOLE CLEANOUT C.O. GUARD POST OR BOLLARD TEMPORARY FENCE TEMPORARY FENCE CONTOUR STRAW BALE EROSION CONTROL CONTOUR TOP OF SLOPE CRUSHED STONE MOWING STRIP
DECIDUOUS TREE SHRUB CONCRETE BOULDER ROW OF BOULDERS LANDSCAPED AREA GRAVEL LEDGE OUTCROP DRAINAGE FLOW DIRECTION ARROW CHAIN LINK FENCE TEMPORARY FENCE CHAINLINK FENCE CHAINLINK FENCE OVERHEAD WIRES DRAIN LINE TREE LINE SHRUB LINE SHRUB LINE GUARD POST OR BOLLARD TEMPORARY FENCE CHAIN LINK FENCE CONTOUR 23 TOP OF SLOPE GUARDRAIL CRUSHED STONE MANHOLE CO.O. COLOR TOP OF SLOPE CRUSHED STONE MOWING STRIP
SHRUB CONCRETE BOULDER ROW OF BOULDERS LANDSCAPED AREA GRAVEL LEDGE OUTCROP BOLLARD DRAINAGE FLOW DIRECTION ARROW CHAINLINK FENCE OVERHEAD WIRES DRAIN LINE TREE LINE SPOT ELEVATION SHRUB C.O. O CHAIN LINK FENCE X X TEMPORARY FENCE CONTOUR 23 CONTOUR TREE LINE SPOT ELEVATION X 23.50 TOP OF SLOPE GUARD POST OR BOLLARD TEMPORARY FENCE CONTOUR X X X X X X X X X X X X X
CONCRETE BOULDER ROW OF BOULDERS LANDSCAPED AREA GRAVEL LEDGE OUTCROP BOLLARD DRAINAGE FLOW DIRECTION ARROW CHAINLINK FENCE OVERHEAD WIRES DRAIN LINE TREE LINE SHRUB LINE GUARD POST OR BOLLARD TEMPORARY FENCE CHAIN LINK FENCE STRAW BALE EROSION CONTROL CONTOUR 23 CONTOUR TREE LINE SPOT ELEVATION X 23.50 TOP OF SLOPE GUARD POST OR BOLLARD TEMPORARY FENCE CONTOUR CONTOUR CONTOUR CONTOUR CRUSHED STONE MOWING STRIP
ROW OF BOULDERS LANDSCAPED AREA GRAVEL LEDGE OUTCROP BOLLARD DRAINAGE FLOW DIRECTION ARROW CHAINLINK FENCE OVERHEAD WIRES DRAIN LINE TREE LINE SPOT ELEVATION TOP OF SLOPE GUARDRAIL CRUSHED STONE MOWING STRIP
LANDSCAPED AREA GRAVEL LEDGE OUTCROP BOLLARD DRAINAGE FLOW DIRECTION ARROW CHAIN LINK FENCE TEMPORARY FENCE TEMPORARY FENCE TEMPORARY FENCE TEMPORARY FENCE TEMPORARY FENCE CONTOUR STRAW BALE EROSION CONTROL CONTOUR TREE LINE SPOT ELEVATION X 23.50 TOP OF SLOPE GUARDRAIL CONTOUR LINE CRUSHED STONE MOWING STRIP
GRAVEL LEDGE OUTCROP BOLLARD DRAINAGE FLOW DIRECTION ARROW CHAINLINK FENCE OVERHEAD WIRES DRAIN LINE TREE LINE SPOT ELEVATION SHRUB LINE CONTOUR CRUSHED STONE MOWING STRIP CRUSHED STONE MOWING STRIP
LEDGE OUTCROP BOLLARD DRAINAGE FLOW DIRECTION ARROW CHAINLINK FENCE OVERHEAD WIRES DRAIN LINE TREE LINE SPOT ELEVATION X 23.50 SHRUB LINE GUARDRAIL CONTOUR LINE CRUSHED STONE MOWING STRIP
BOLLARD DRAINAGE FLOW DIRECTION ARROW CHAINLINK FENCE OHW OVERHEAD WIRES DRAIN LINE TREE LINE SPOT ELEVATION X 23.50 SHRUB LINE GUARDRAIL CONTOUR LINE CRUSHED STONE MOWING STRIP
DRAINAGE FLOW DIRECTION ARROW CHAINLINK FENCE OHW OVERHEAD WIRES DRAIN LINE TREE LINE SPOT ELEVATION X 23.50 SHRUB LINE GUARDRAIL CONTOUR LINE CRUSHED STONE MOWING STRIP
CHAINLINK FENCE OHW—OVERHEAD WIRES DRAIN LINE TREE LINE SPOT ELEVATION X 23.50 SHRUB LINE TOP OF SLOPE GUARDRAIL CRUSHED STONE MOWING STRIP
DRAIN LINE TREE LINE SPOT ELEVATION X 23.50 SHRUB LINE TOP OF SLOPE GUARDRAIL CONTOUR
TREE LINE SPOT ELEVATION × 23.50 SHRUB LINE TOP OF SLOPE GUARDRAIL CONTOUR LINE CRUSHED STONE MOWING STRIP EDGE OF JURISDICTIONAL WETLAND
SHRUB LINE GUARDRAIL CONTOUR LINE EDGE OF JURISDICTIONAL WETLAND TOP OF SLOPE CRUSHED STONE MOWING STRIP
GUARDRAIL ———————————————————————————————————
MOWING STRIP EDGE OF JURISDICTIONAL WETLAND
DODINO
B13-1 BORING CONCRETE
MW-1 MONITORING WELL CURB
TEST PIT
EXISTING PAVEMENT AREA TO BE REPAVED (RECLAIMED BASE)
— — — — HIGHEST OBSERVABLE TIDE LINE NEW PAVEMENT AREA
POINT OF CONNECTION, NEW WORK TO EXIST.
JERSEY BARRIER WITH PILED SAND
THE TENTH OF THE PILED SAND PILED SAND FLOOD HAZARD AREA
EXIST. TEMPORARY FILL

PROJECT

PEIRCE ISLAND FORCE MAIN AND WATER MAIN REPLACEMENT Peirce Island, Portsmouth NH

OWNER

CITY OF PORTSMOUTH **NEW HAMPSHIRE**

680 Peverly Hill Road Portsmouth, NH 03801

ENGINEER

AECOM TECHNICAL SERVICES, INC. 250 APOLLO DRIVE CHELMSFORD, MA 01824 PHONE: (978) 905-2100 www.aecom.com

REGISTRATION



PROJECT NUMBER

I/R DATE DESCRIPTION

60649477


Designed By:	S. HE
Drawn By:	M. THIBODEAU
Dept Check:	C. BENZIGER
Proj Check:	E. MESERVE
Date:	AUGUST 2021
Scale:	AS NOTED

DISCIPLINE

CIVIL SHEET TITLE

LEGEND, ABBREVIATIONS AND GENERAL NOTES

SHEET NUMBER

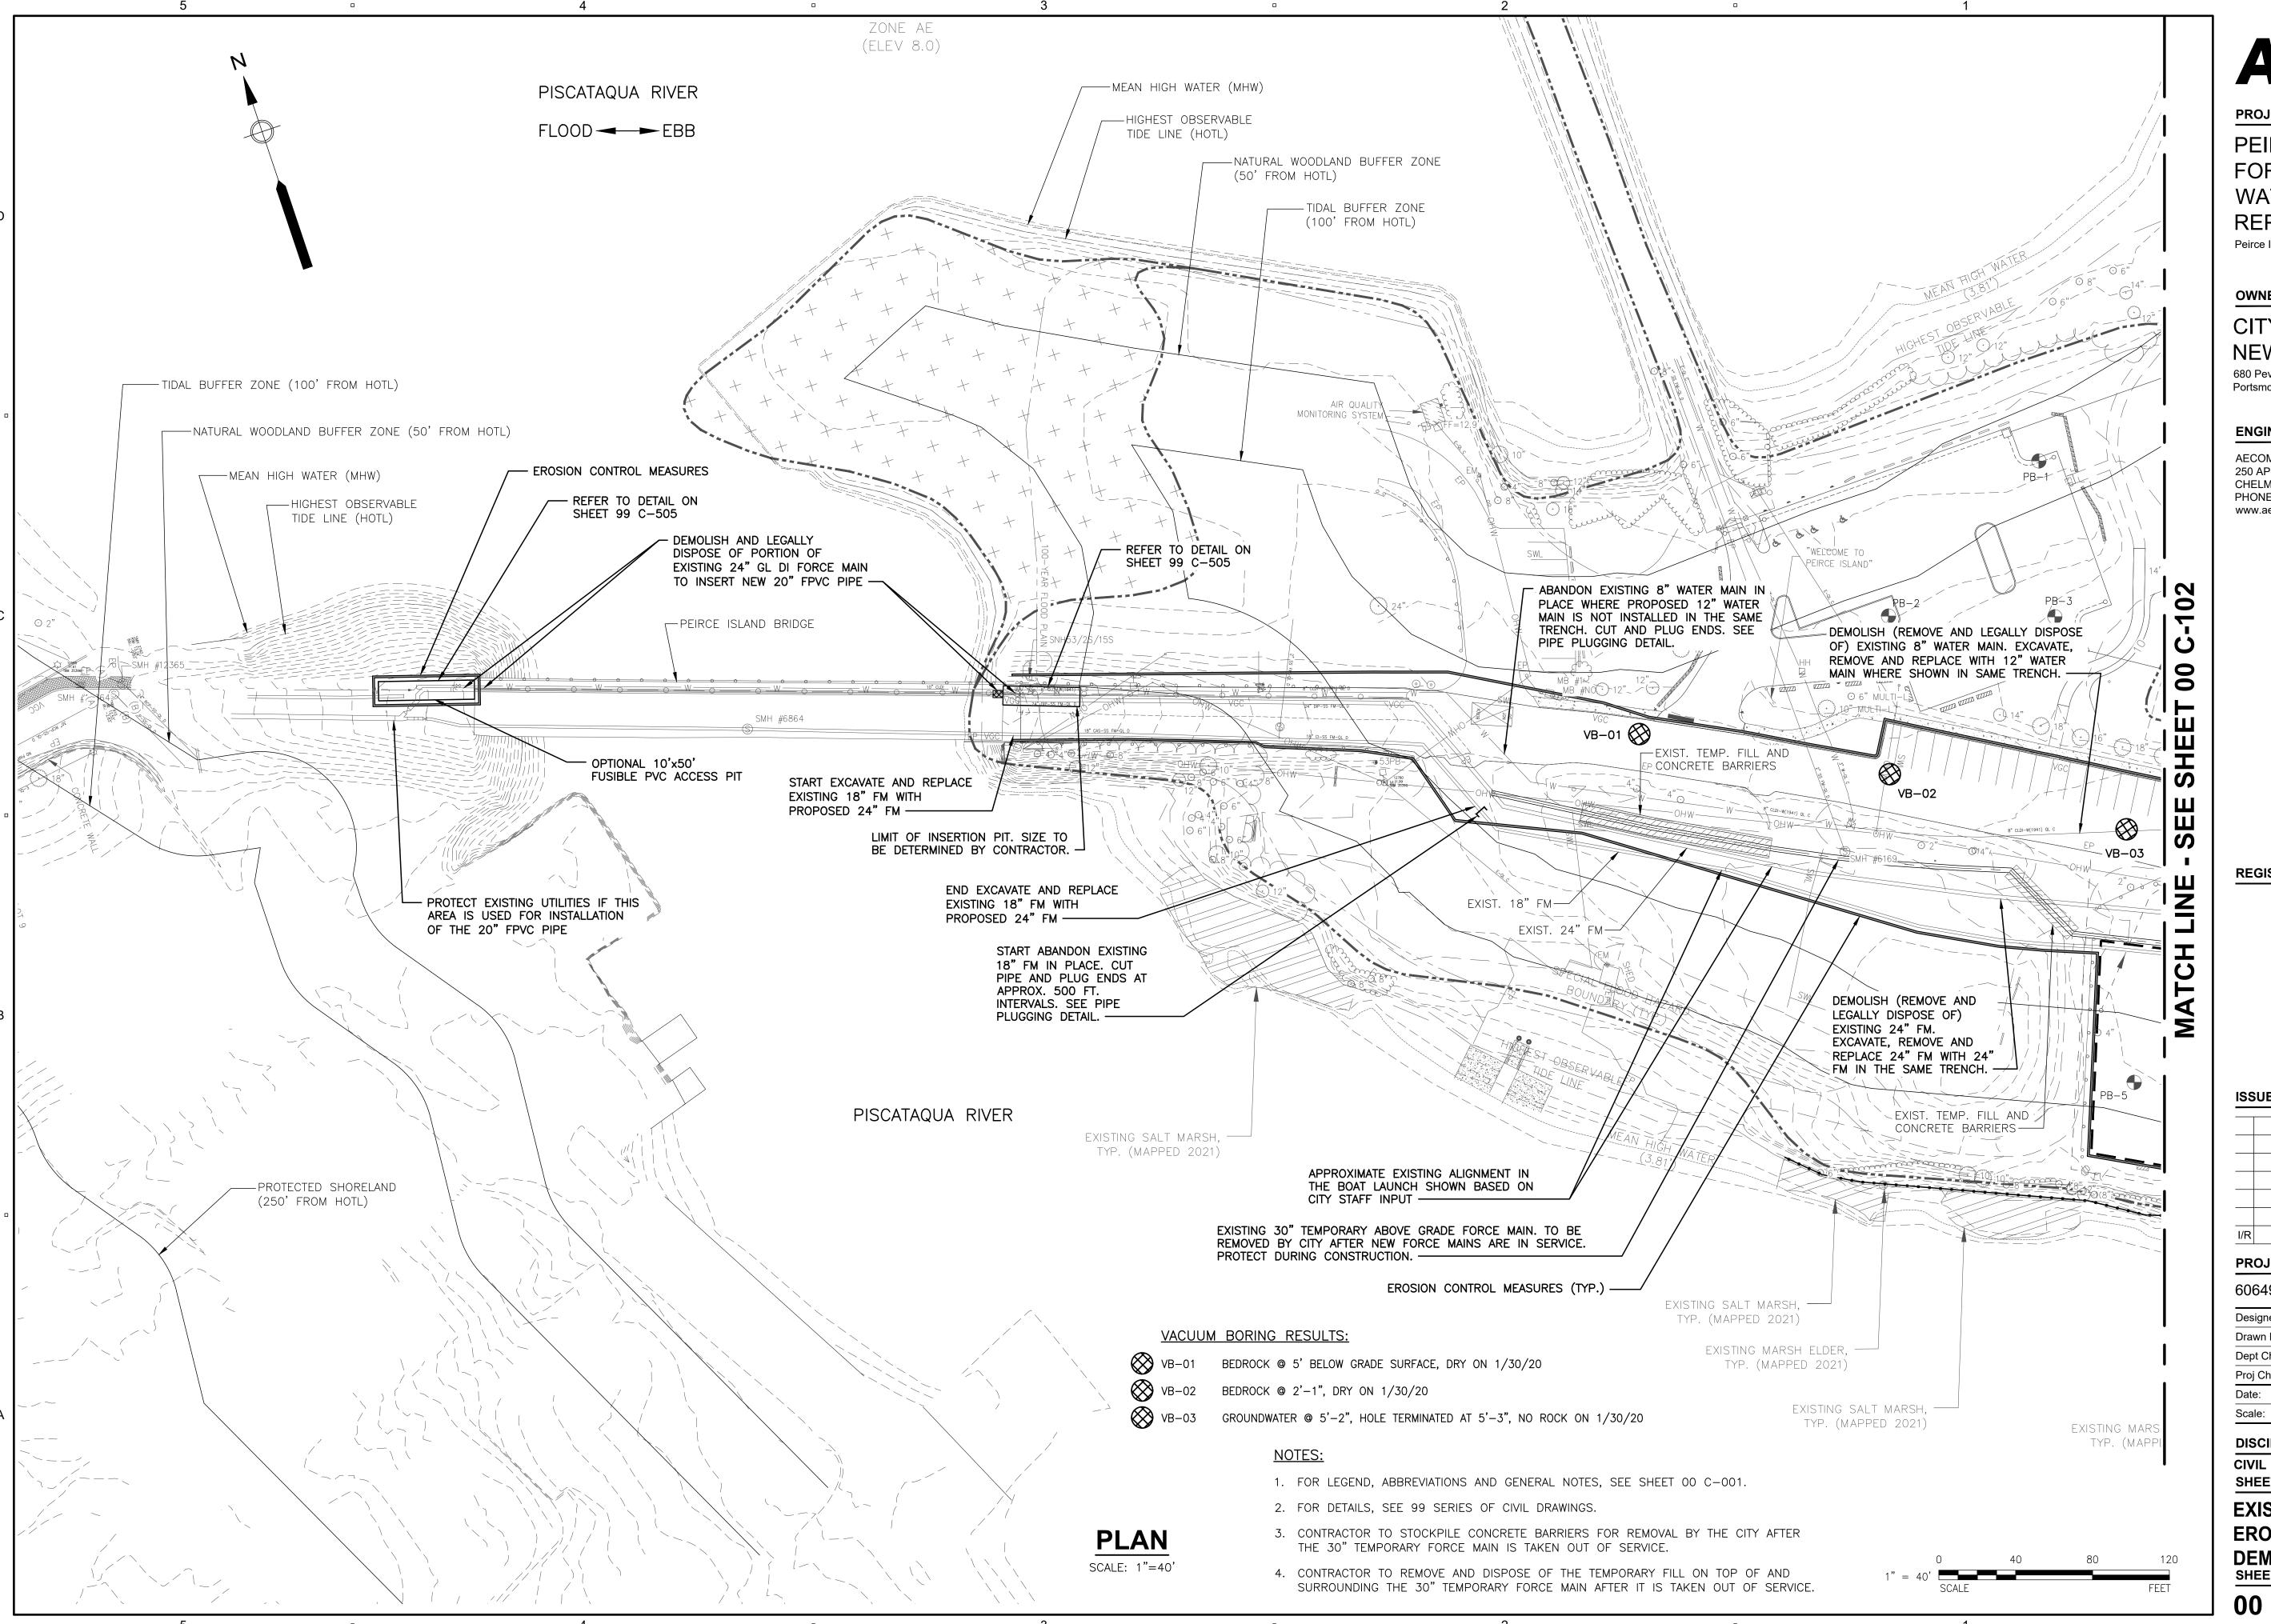

PROJECT

PEIRCE ISLAND FORCE MAIN AND WATER MAIN REPLACEMENT Peirce Island, Portsmouth NH

OWNER

CITY OF PORTSMOUTH **NEW HAMPSHIRE**

680 Peverly Hill Road Portsmouth, NH 03801

ENGINEER

AECOM TECHNICAL SERVICES, INC. 250 APOLLO DRIVE CHELMSFORD, MA 01824 PHONE: (978) 905-2100 www.aecom.com

REGISTRATION



ISSUE/REVISION

I/F	DATE	DESCRIPTION

PROJECT NUMBER


60649477

Designed By:	S. HE
Drawn By:	M. THIBODEAU
Dept Check:	C. BENZIGER
Proj Check:	E. MESERVE
Date:	AUGUST 2021
Scale:	AS NOTED

DISCIPLINE

SHEET TITLE

EXISTING CONDITIONS, EROSION CONTROL AND DEMOLITION PLAN I SHEET NUMBER

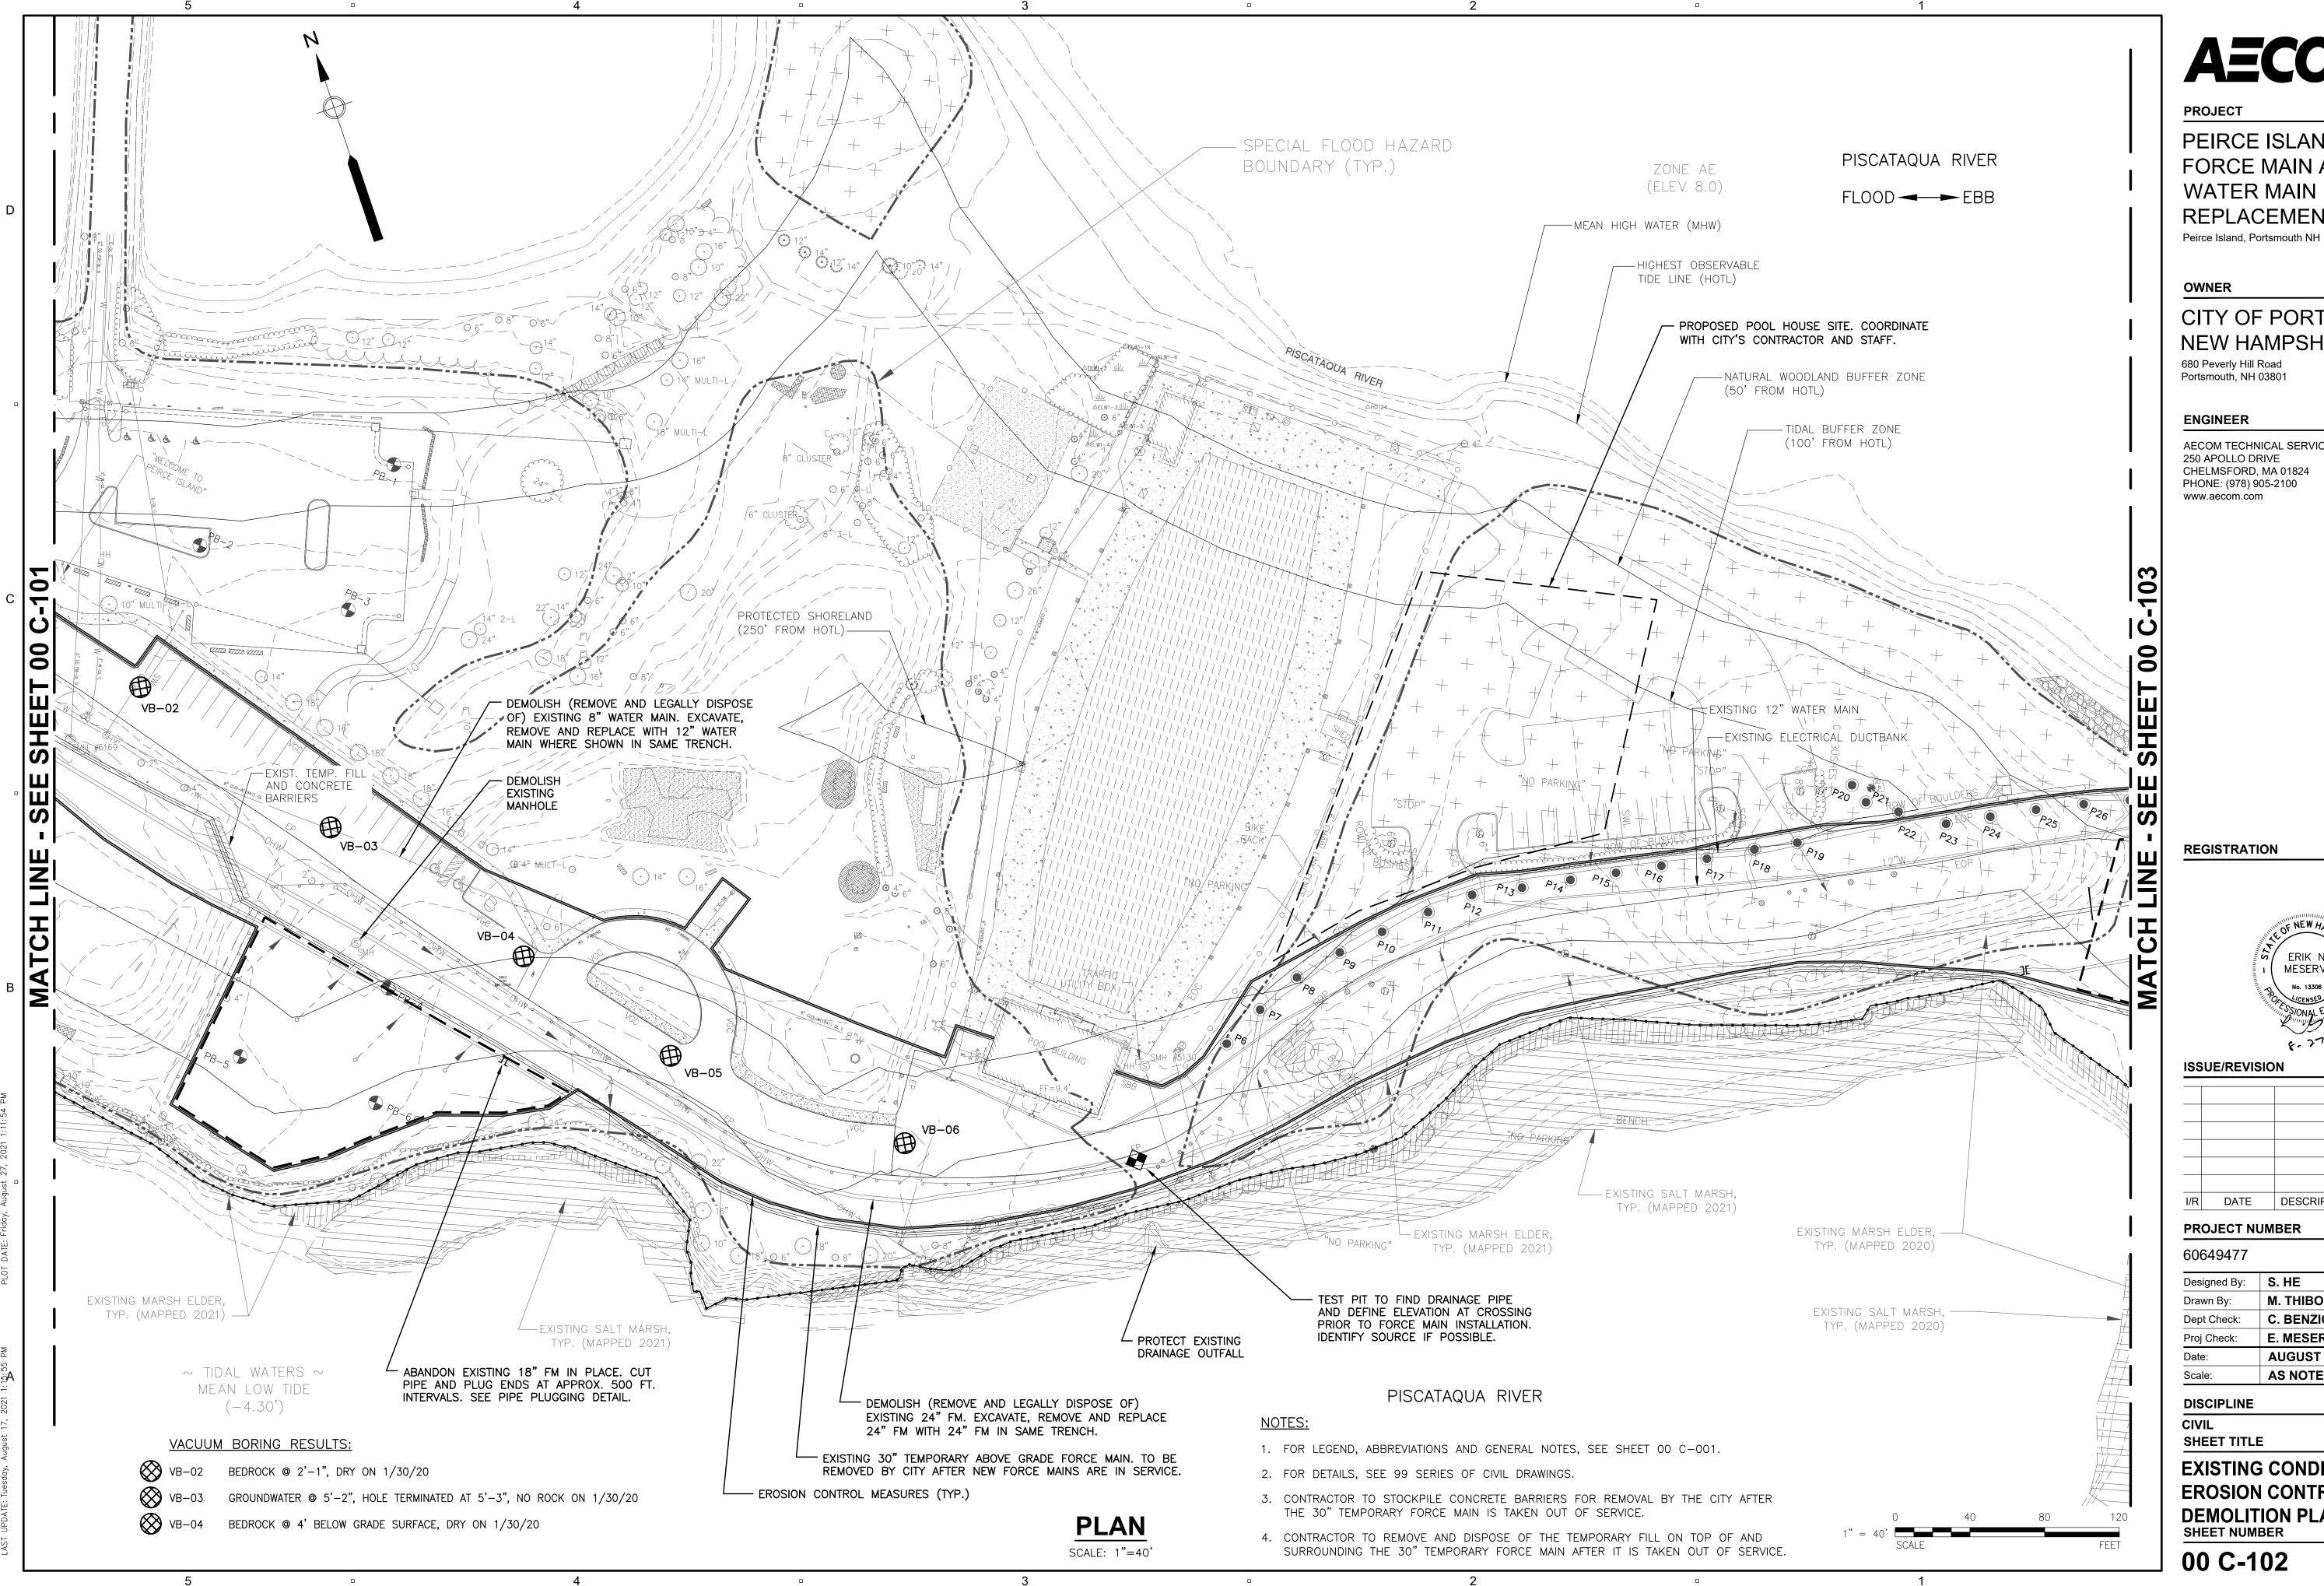

PEIRCE ISLAND FORCE MAIN AND WATER MAIN REPLACEMENT

CITY OF PORTSMOUTH **NEW HAMPSHIRE**


AECOM TECHNICAL SERVICES, INC.



I/R	DATE	DESCRIPTION

Designed By:	S. HE
Drawn By:	M. THIBODEAU
Dept Check:	C. BENZIGER
Proj Check:	E. MESERVE
Date:	AUGUST 2021
Scale:	AS NOTED

EXISTING CONDITIONS, EROSION CONTROL AND DEMOLITION PLAN II

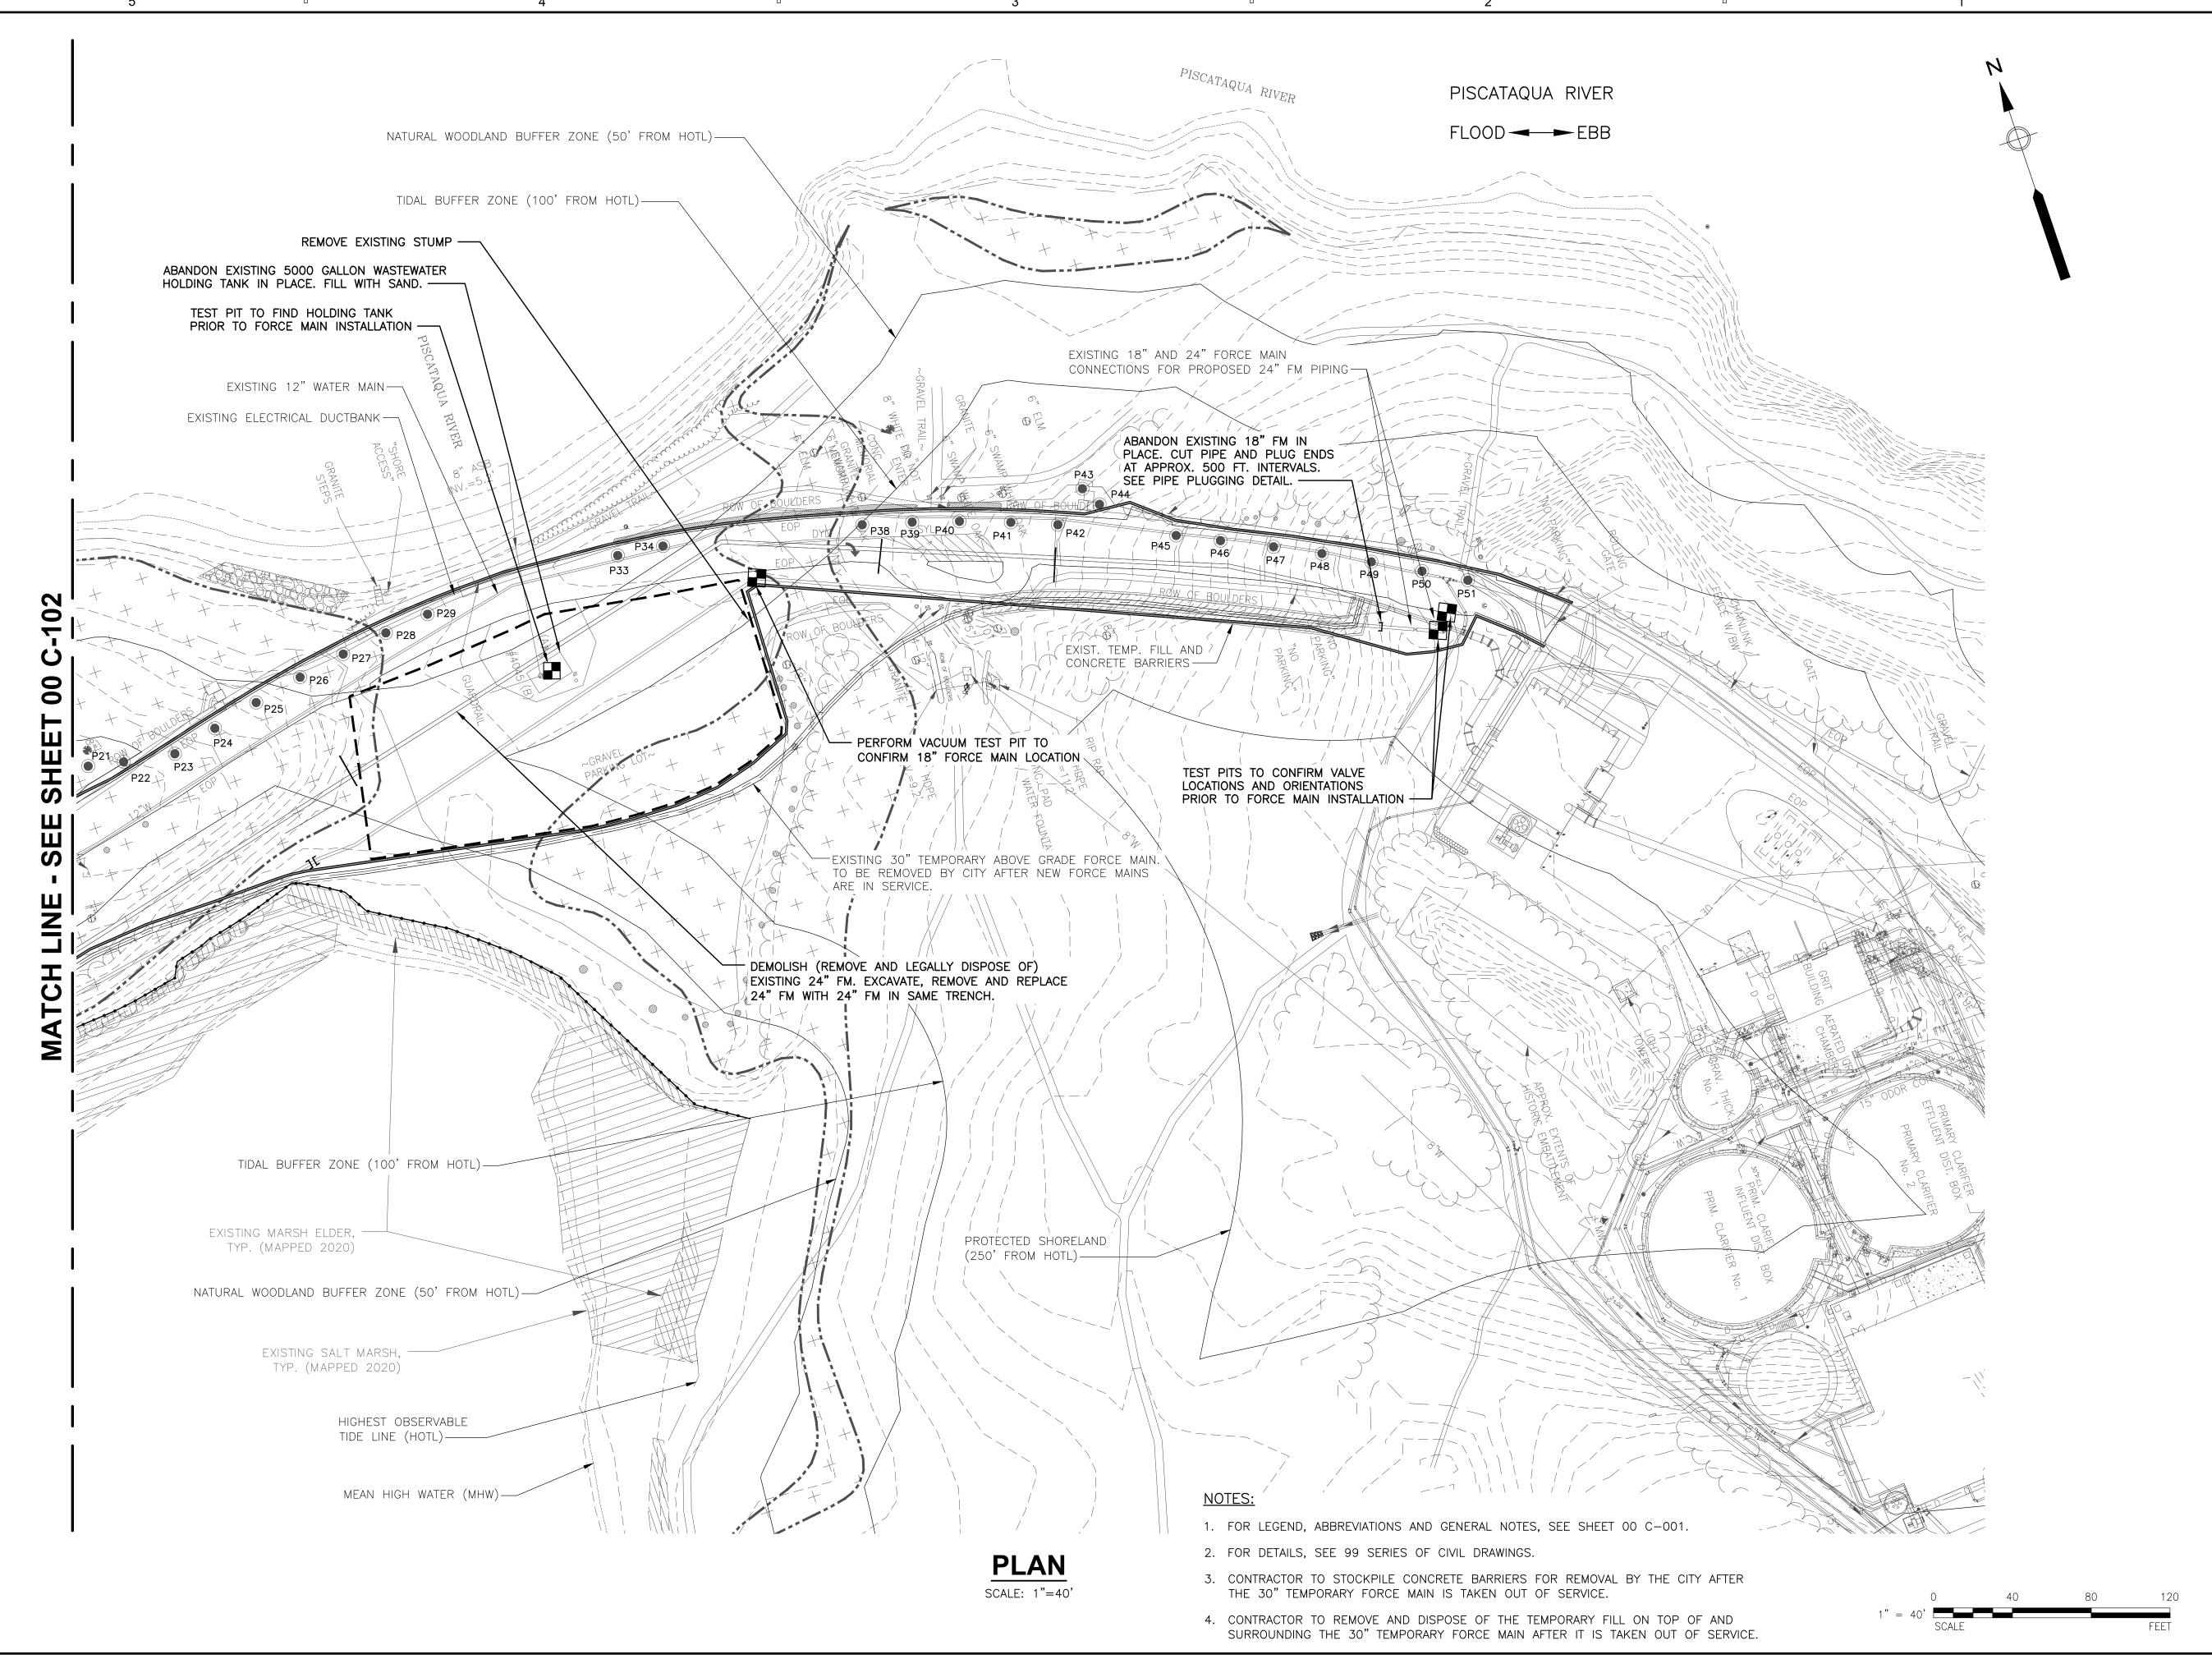

PROJECT

PEIRCE ISLAND
FORCE MAIN AND
WATER MAIN
REPLACEMENT
Peirce Island, Portsmouth NH

OWNER

CITY OF PORTSMOUTH NEW HAMPSHIRE

680 Peverly Hill Road Portsmouth, NH 03801

ENGINEER

AECOM TECHNICAL SERVICES, INC. 250 APOLLO DRIVE CHELMSFORD, MA 01824 PHONE: (978) 905-2100 www.aecom.com

REGISTRATION



ISSUE/REVISION

I/R	DATE	DESCRIPTION

PROJECT NUMBER


60649477

Designed By:	S. HE
Drawn By:	M. THIBODEAU
Dept Check:	C. BENZIGER
Proj Check:	E. MESERVE
Date:	AUGUST 2021
Scale:	AS NOTED

DISCIPLINE

CIVIL SHEET TITLE

EXISTING CONDITIONS, EROSION CONTROL AND DEMOLITION PLAN III SHEET NUMBER

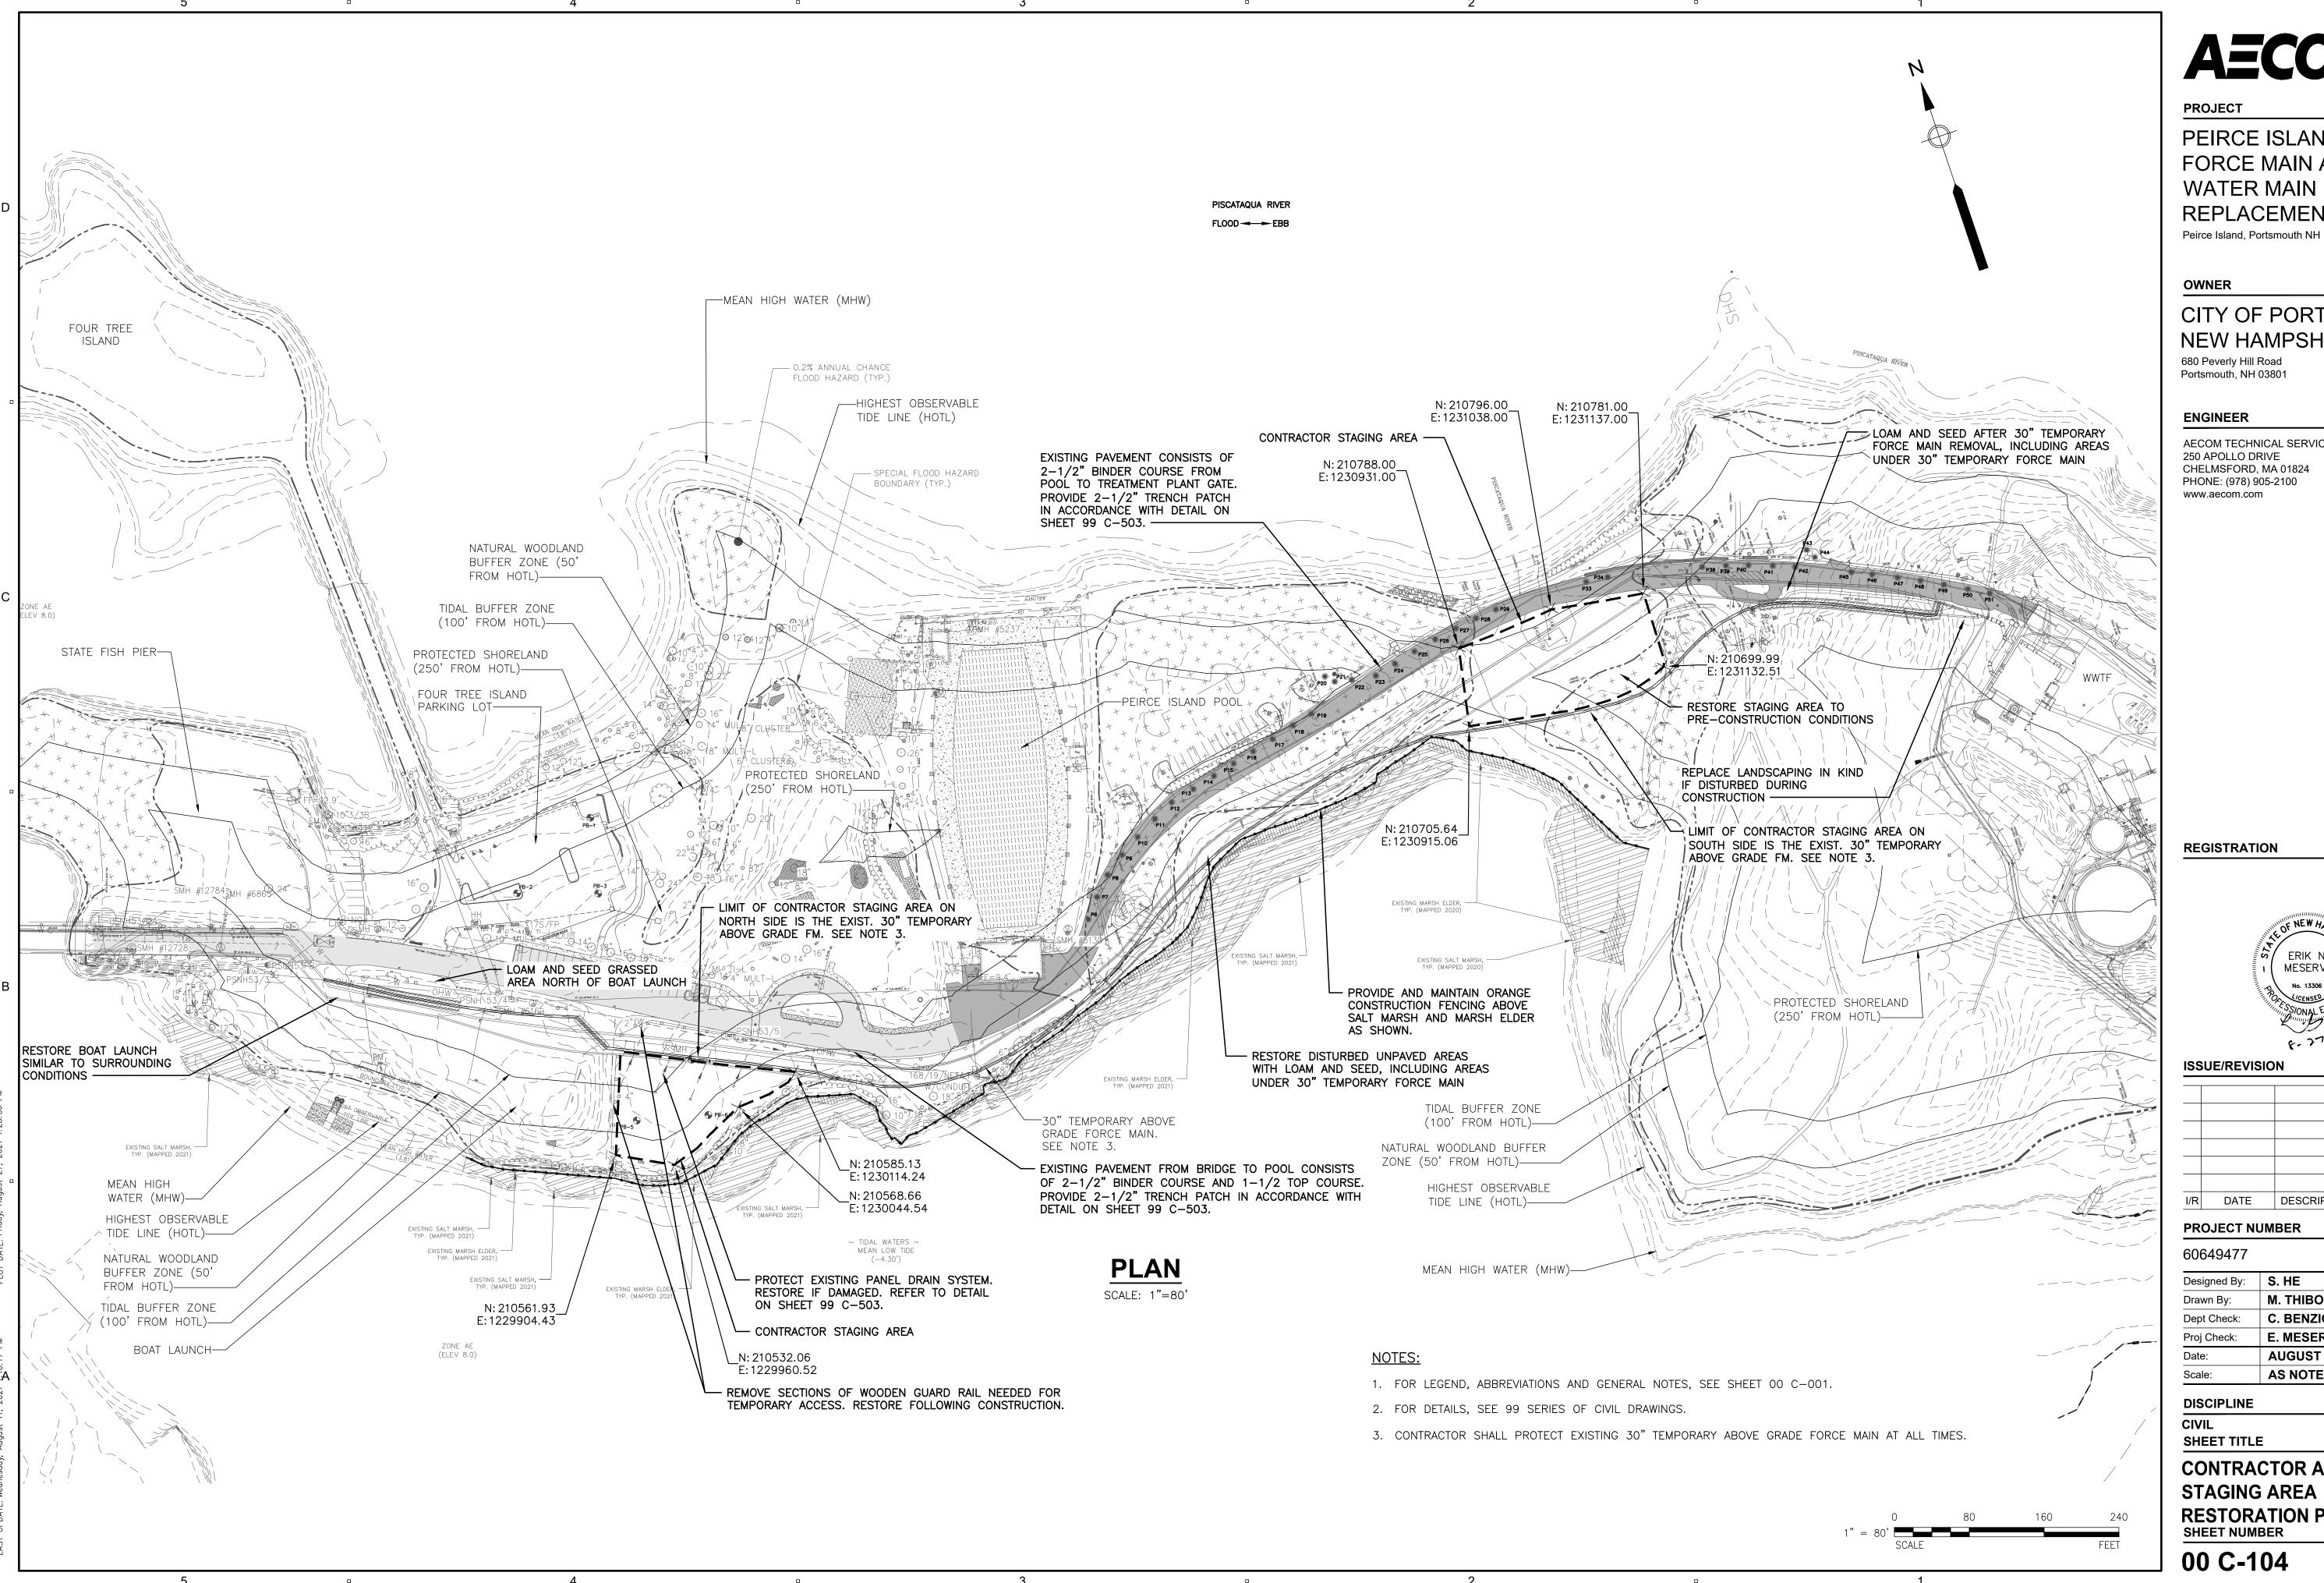

PEIRCE ISLAND FORCE MAIN AND WATER MAIN REPLACEMENT

CITY OF PORTSMOUTH **NEW HAMPSHIRE**


AECOM TECHNICAL SERVICES, INC. CHELMSFORD, MA 01824 PHONE: (978) 905-2100



I/R	DATE	DESCRIPTION

Designed By:	S. HE
Drawn By:	M. THIBODEAU
Dept Check:	C. BENZIGER
Proj Check:	E. MESERVE
Date:	AUGUST 2021
Scale:	AS NOTED

CONTRACTOR ACCESS AND STAGING AREA AND SITE **RESTORATION PLAN**

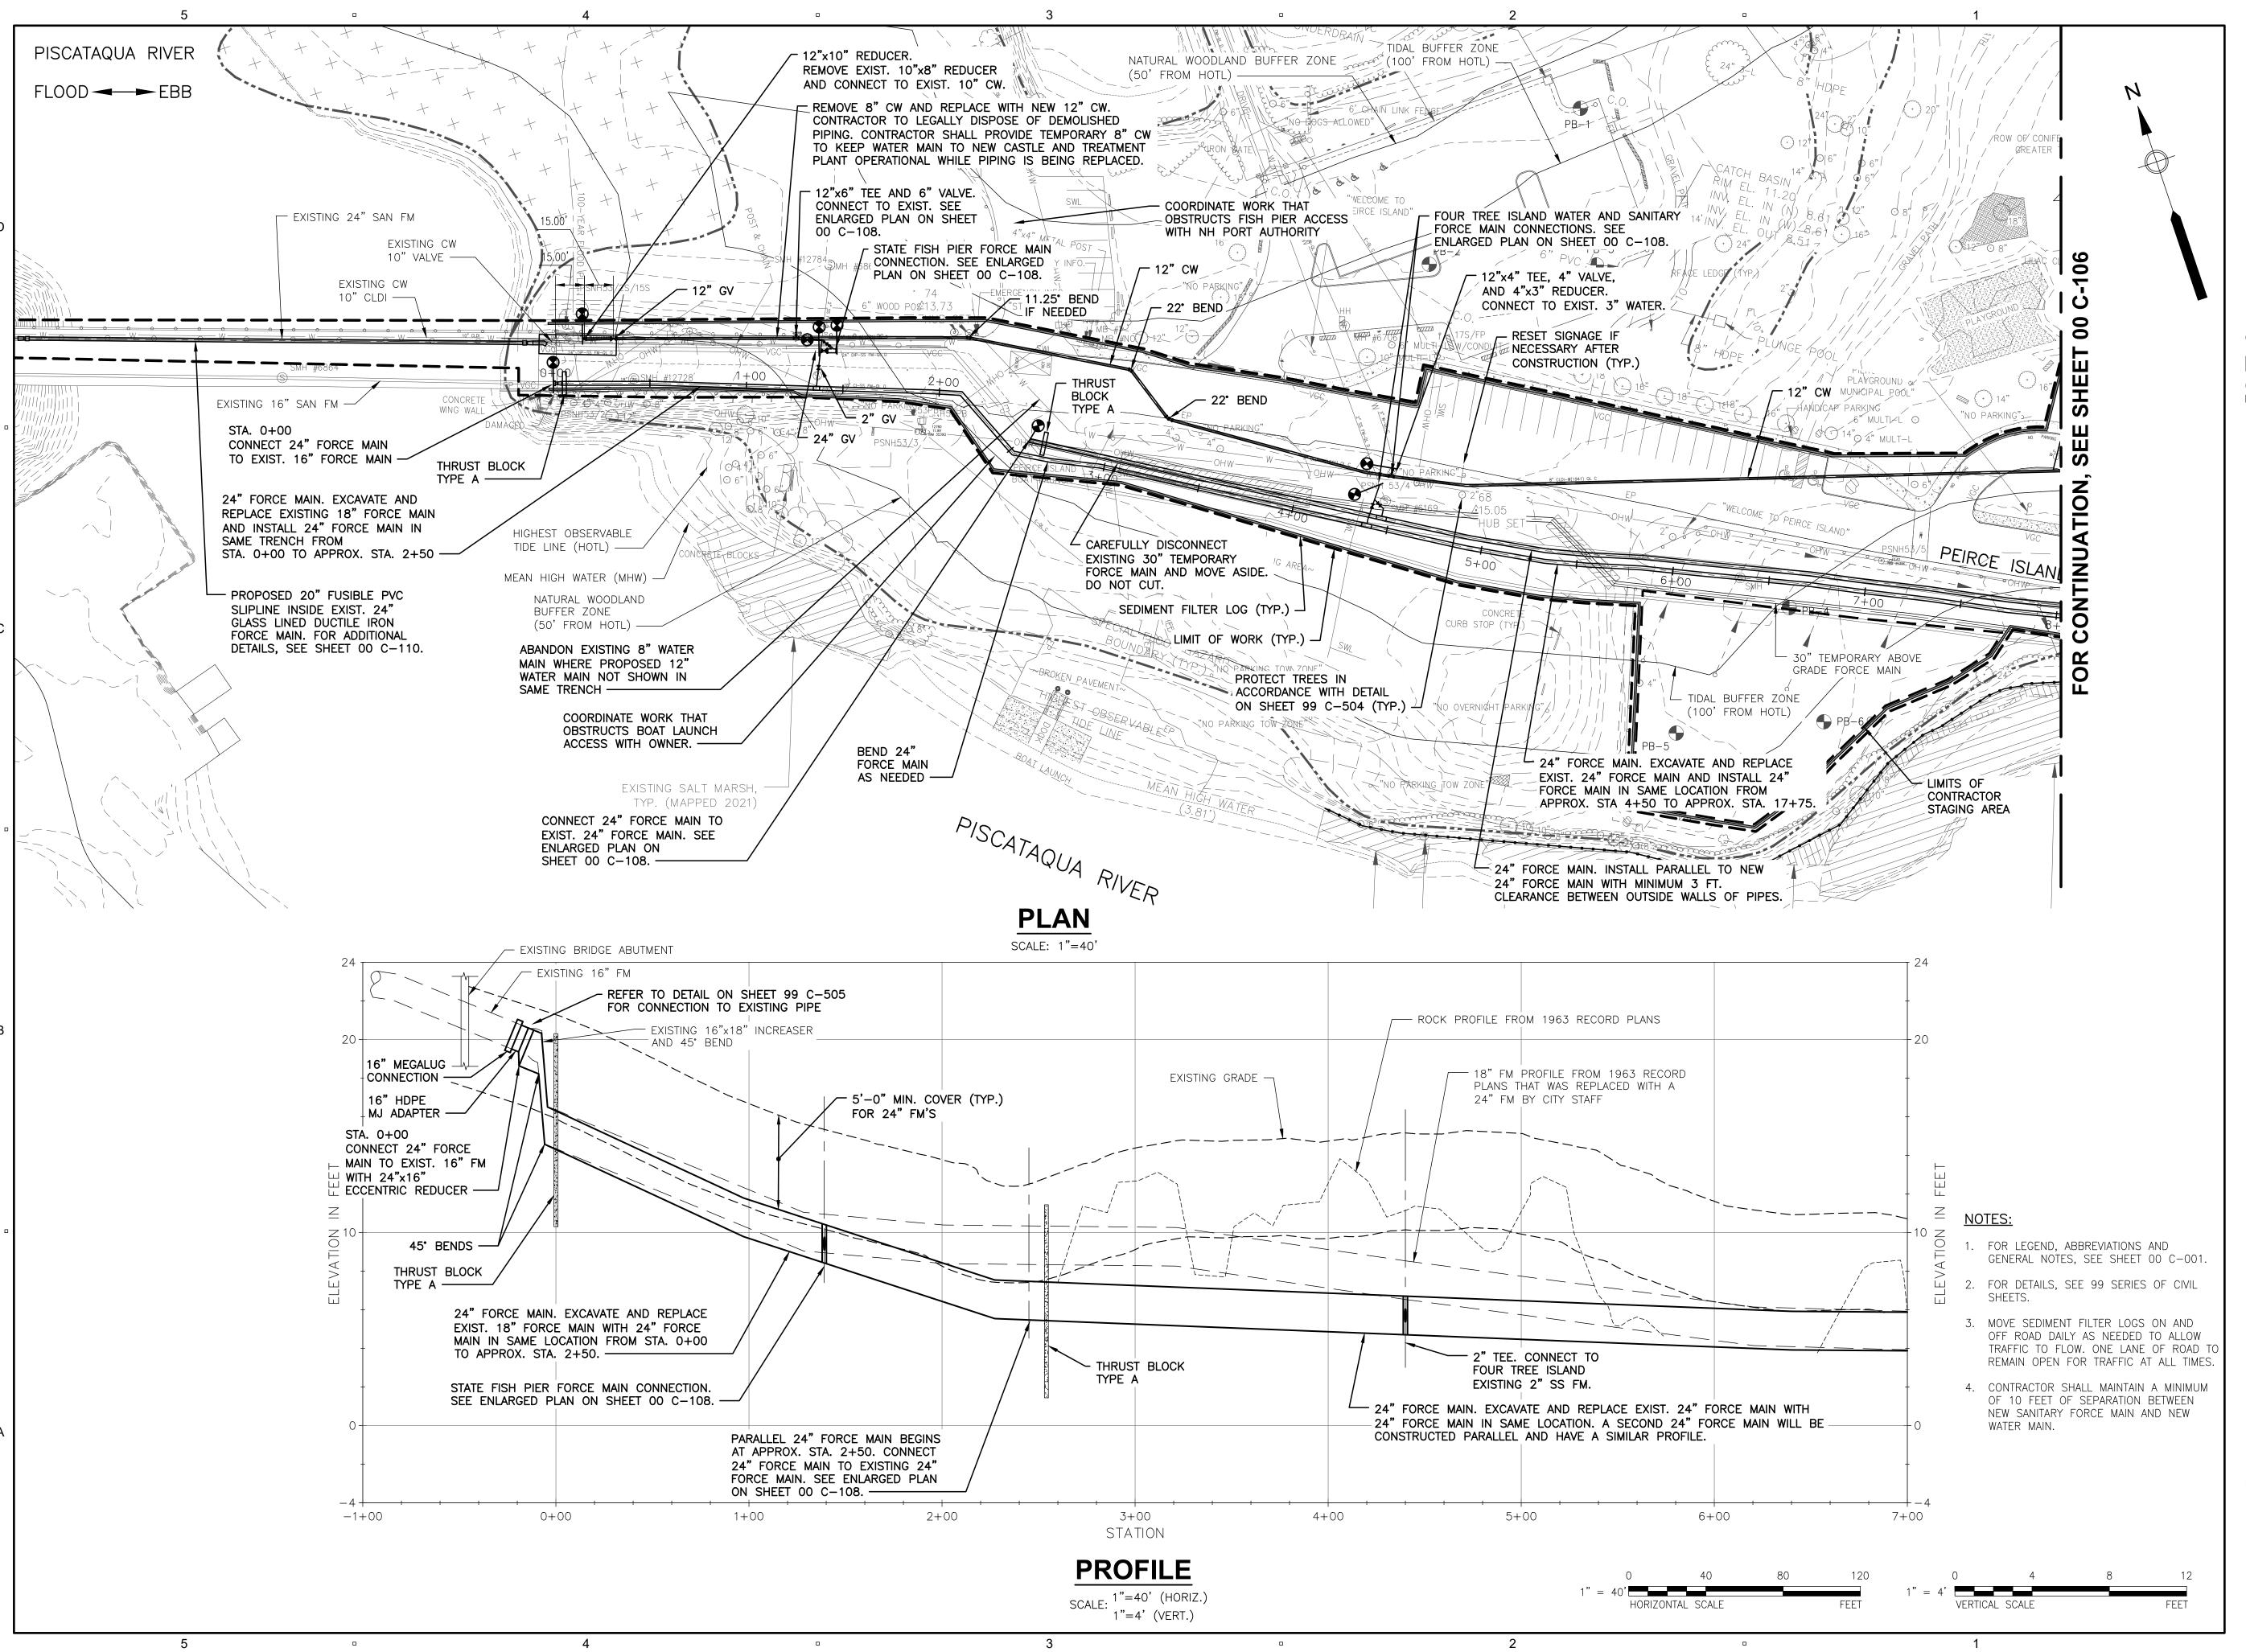

PROJECT

PEIRCE ISLAND
FORCE MAIN AND
WATER MAIN
REPLACEMENT
Peirce Island, Portsmouth NH

OWNER

CITY OF PORTSMOUTH NEW HAMPSHIRE

680 Peverly Hill Road Portsmouth, NH 03801

ENGINEER

AECOM TECHNICAL SERVICES, INC. 250 APOLLO DRIVE CHELMSFORD, MA 01824 PHONE: (978) 905-2100 www.aecom.com

REGISTRATION



ISSUE/REVISION

I/R	DATE	DESCRIPTION

PROJECT NUMBER

60649477


Designed By:	S. HE
Drawn By:	M. THIBODEAU
Dept Check:	C. BENZIGER
Proj Check:	E. MESERVE
Date:	AUGUST 2021
Scale:	AS NOTED

DISCIPLINE

CIVIL SHEET TITLE

PIPING PLAN AND PROFILE I

SHEET NUMBER

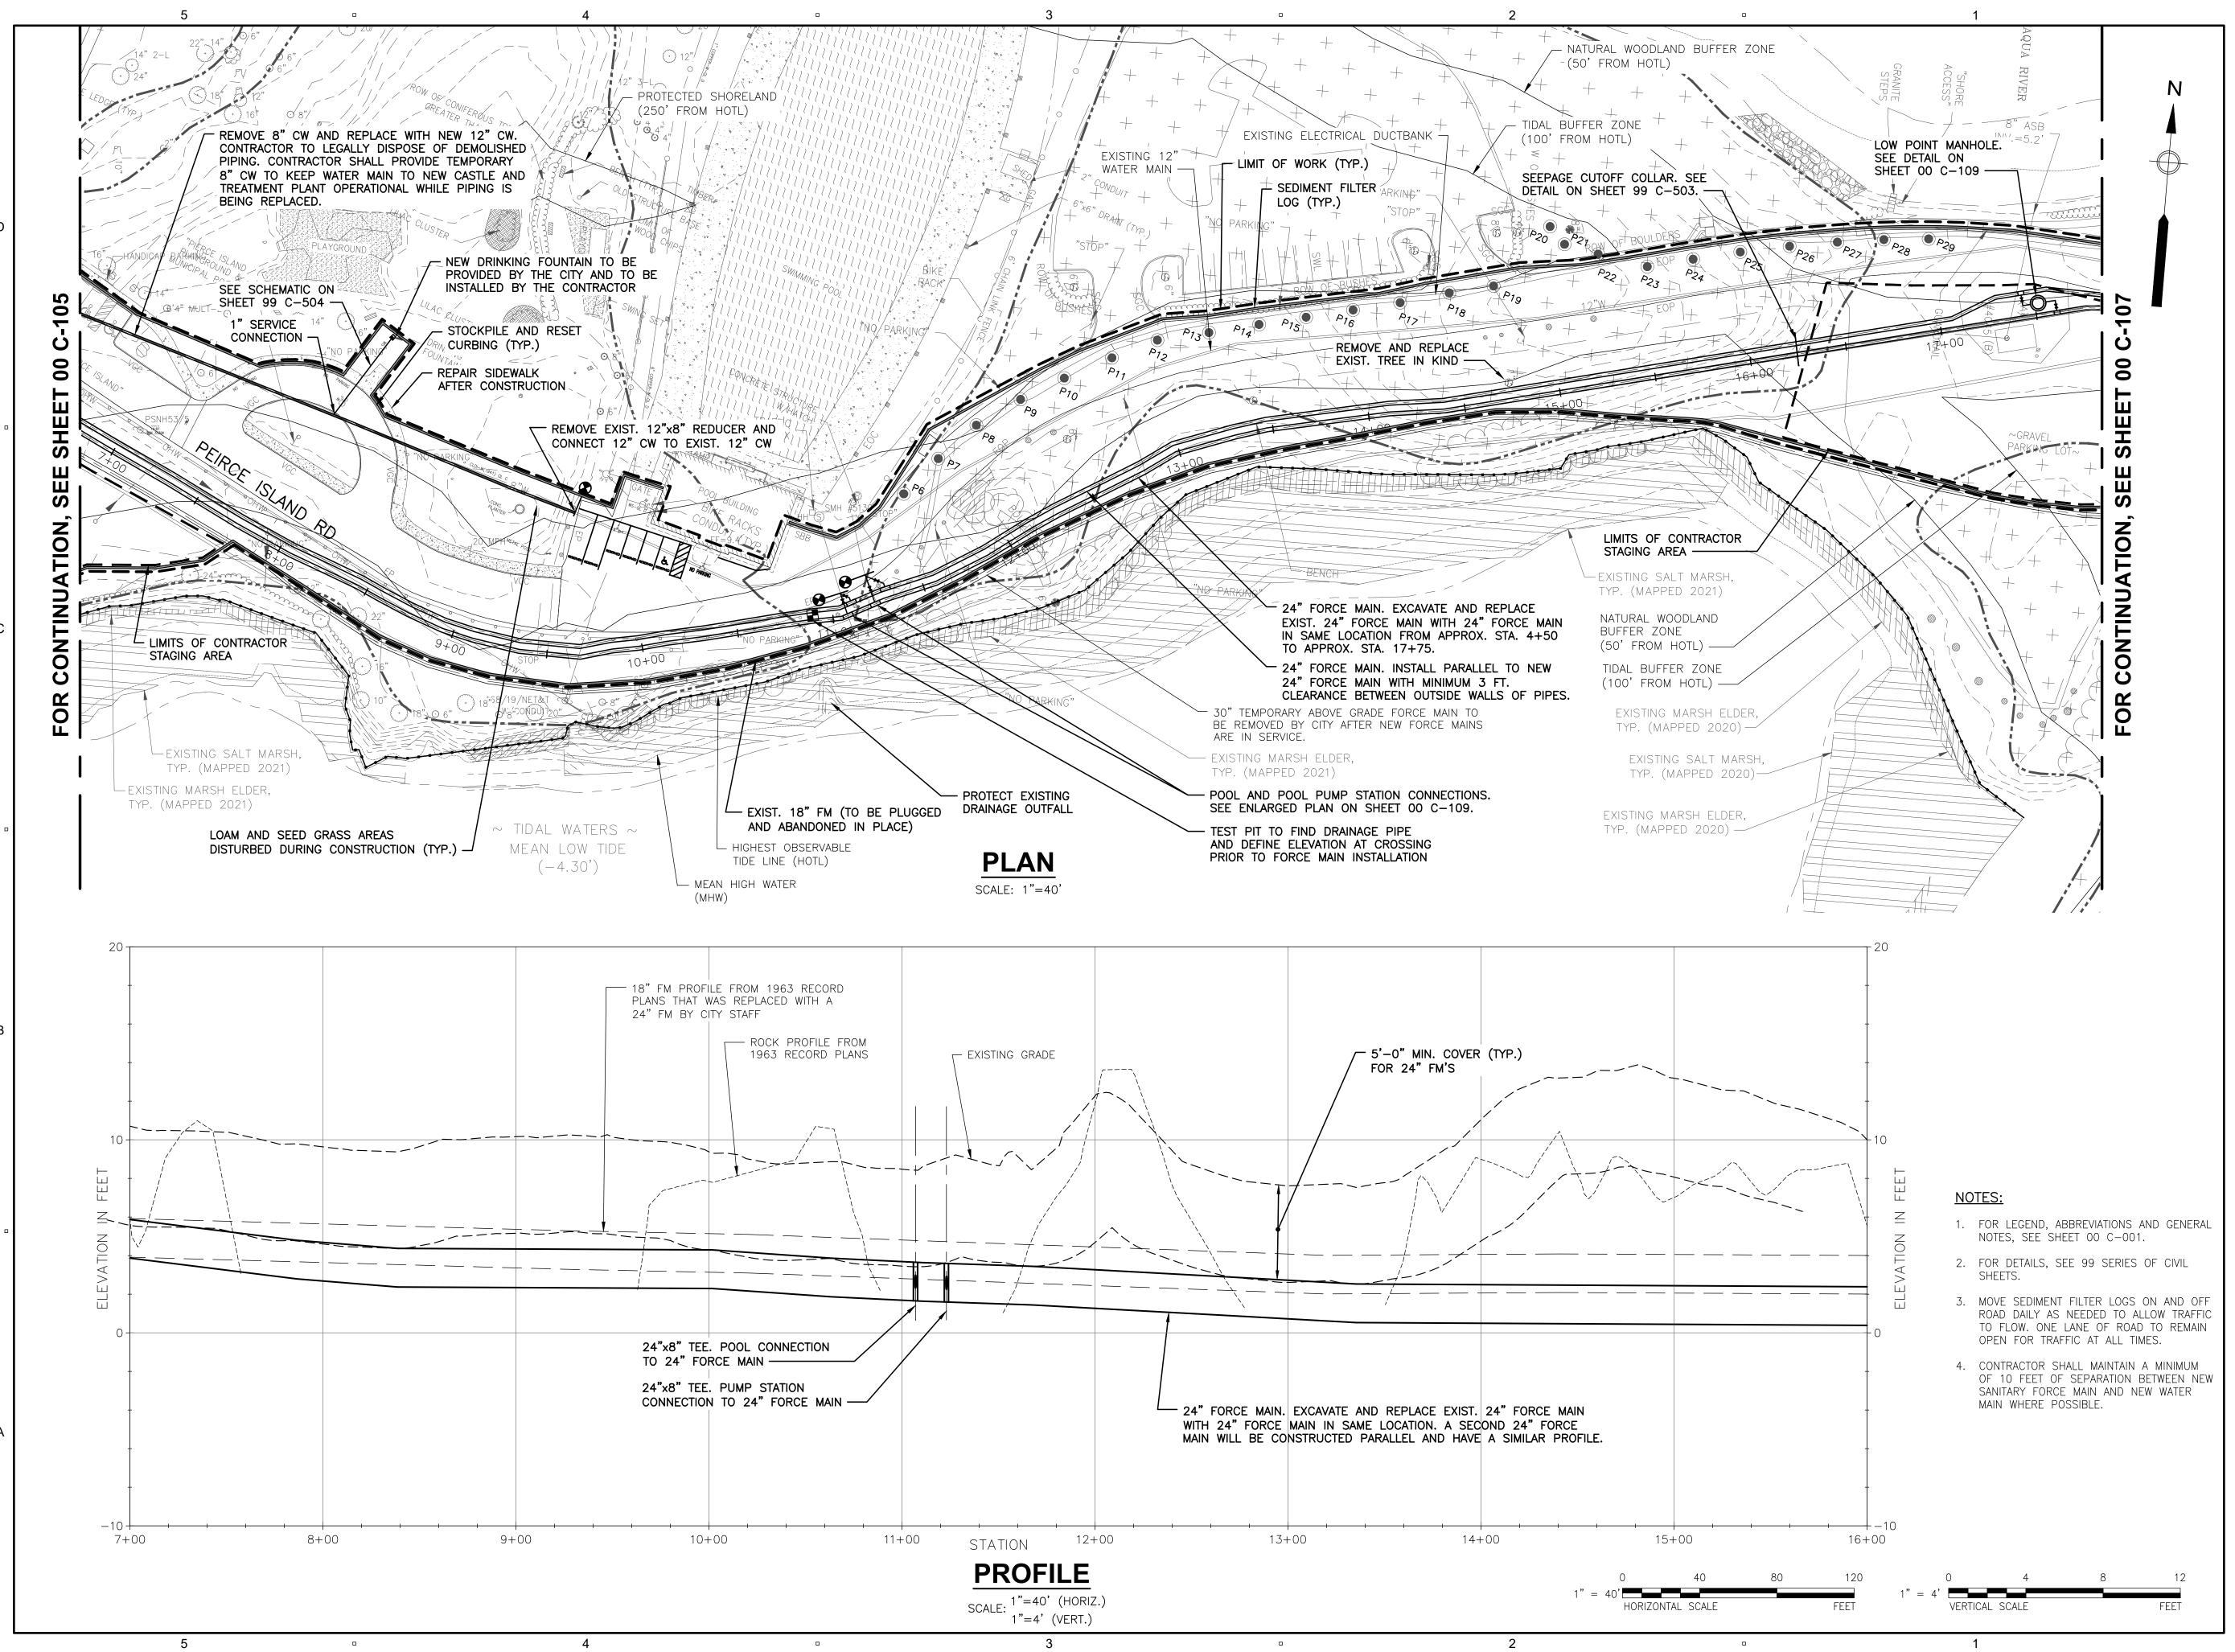

PROJECT

PEIRCE ISLAND
FORCE MAIN AND
WATER MAIN
REPLACEMENT
Peirce Island, Portsmouth NH

OWNER

CITY OF PORTSMOUTH NEW HAMPSHIRE

680 Peverly Hill Road Portsmouth, NH 03801

ENGINEER

AECOM TECHNICAL SERVICES, INC. 250 APOLLO DRIVE CHELMSFORD, MA 01824 PHONE: (978) 905-2100 www.aecom.com

REGISTRATION



ISSUE/REVISION

I/R	DATE	DESCRIPTION

PROJECT NUMBER

60649477


Designed By:	S. HE
Drawn By:	M. THIBODEAU
Dept Check:	C. BENZIGER
Proj Check:	E. MESERVE
Date:	AUGUST 2021
Scale:	AS NOTED

DISCIPLINE

CIVIL SHEET TITLE

PIPING PLAN AND PROFILE II

SHEET NUMBER

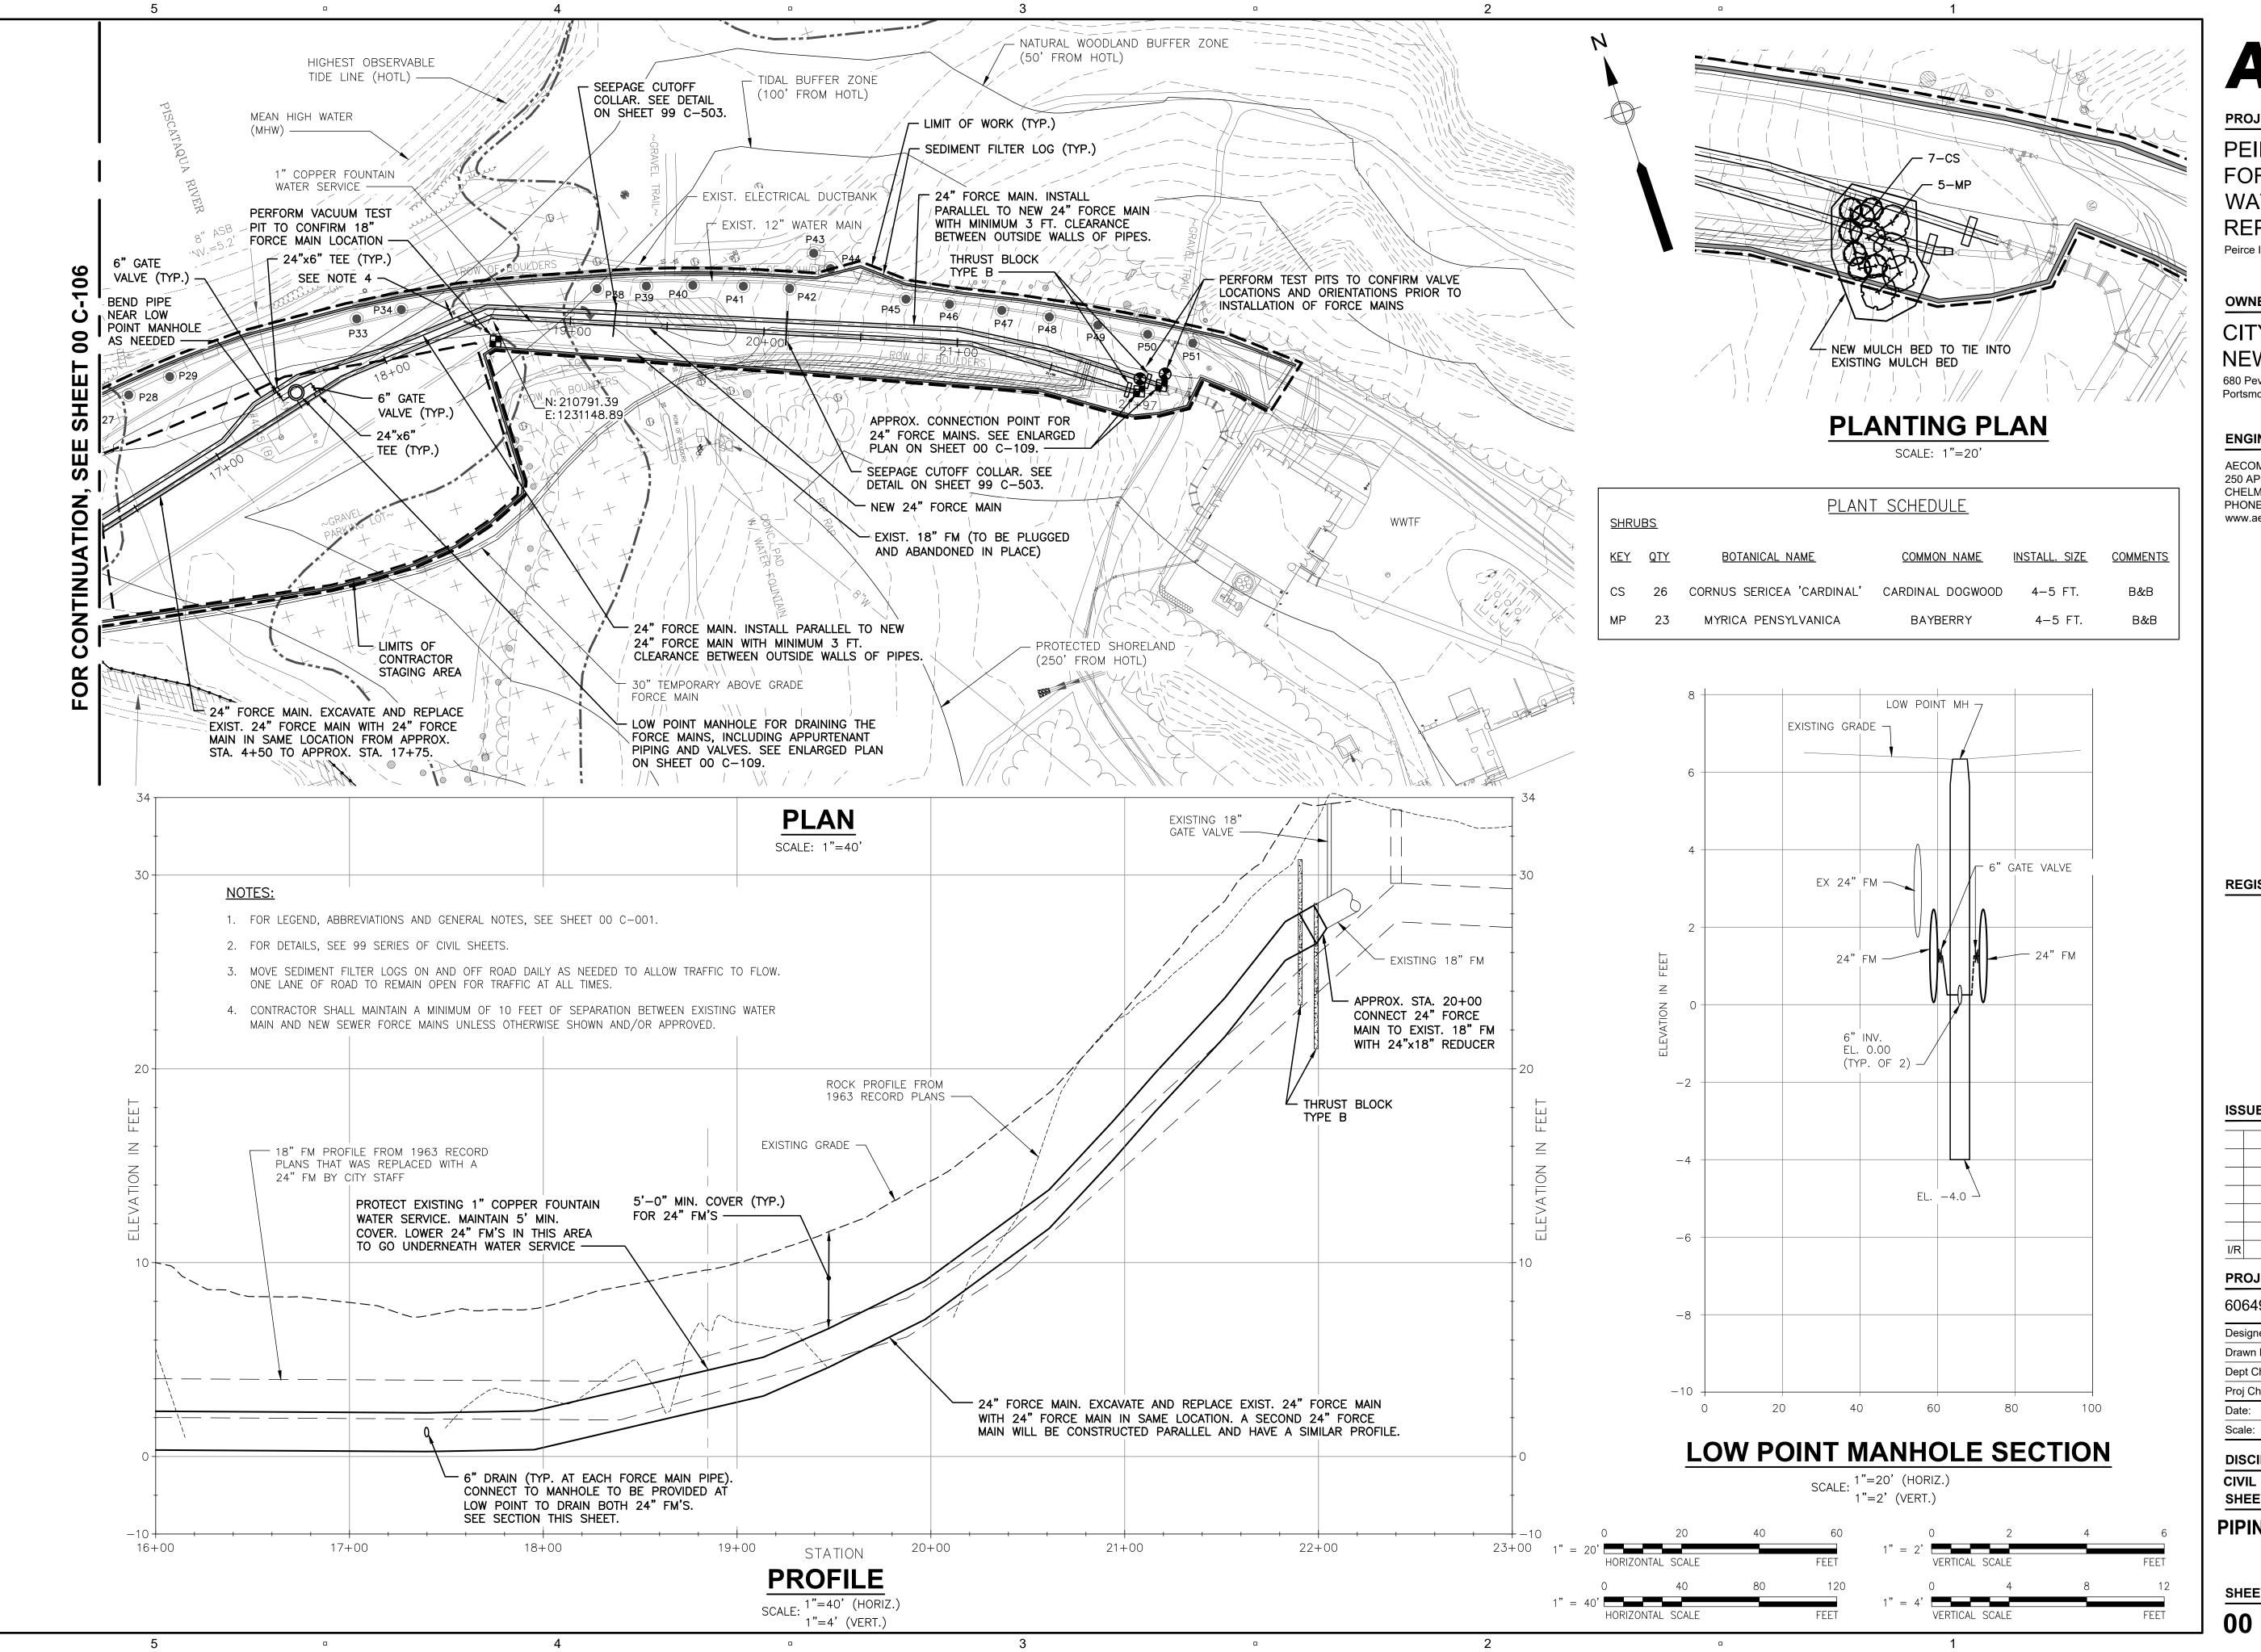

PROJECT

PEIRCE ISLAND FORCE MAIN AND WATER MAIN REPLACEMENT Peirce Island, Portsmouth NH

OWNER

CITY OF PORTSMOUTH **NEW HAMPSHIRE**

680 Peverly Hill Road Portsmouth, NH 03801

ENGINEER

AECOM TECHNICAL SERVICES, INC. 250 APOLLO DRIVE CHELMSFORD, MA 01824 PHONE: (978) 905-2100 www.aecom.com

REGISTRATION



ISSUE/REVISION

I/R	DATE	DESCRIPTION

PROJECT NUMBER

60649477


Designed By:	S. HE
Drawn By:	M. THIBODEAU
Dept Check:	C. BENZIGER
Proj Check:	E. MESERVE
Date:	AUGUST 2021
Scale:	AS NOTED

DISCIPLINE


SHEET TITLE

PIPING PLAN AND PROFILE III

SHEET NUMBER

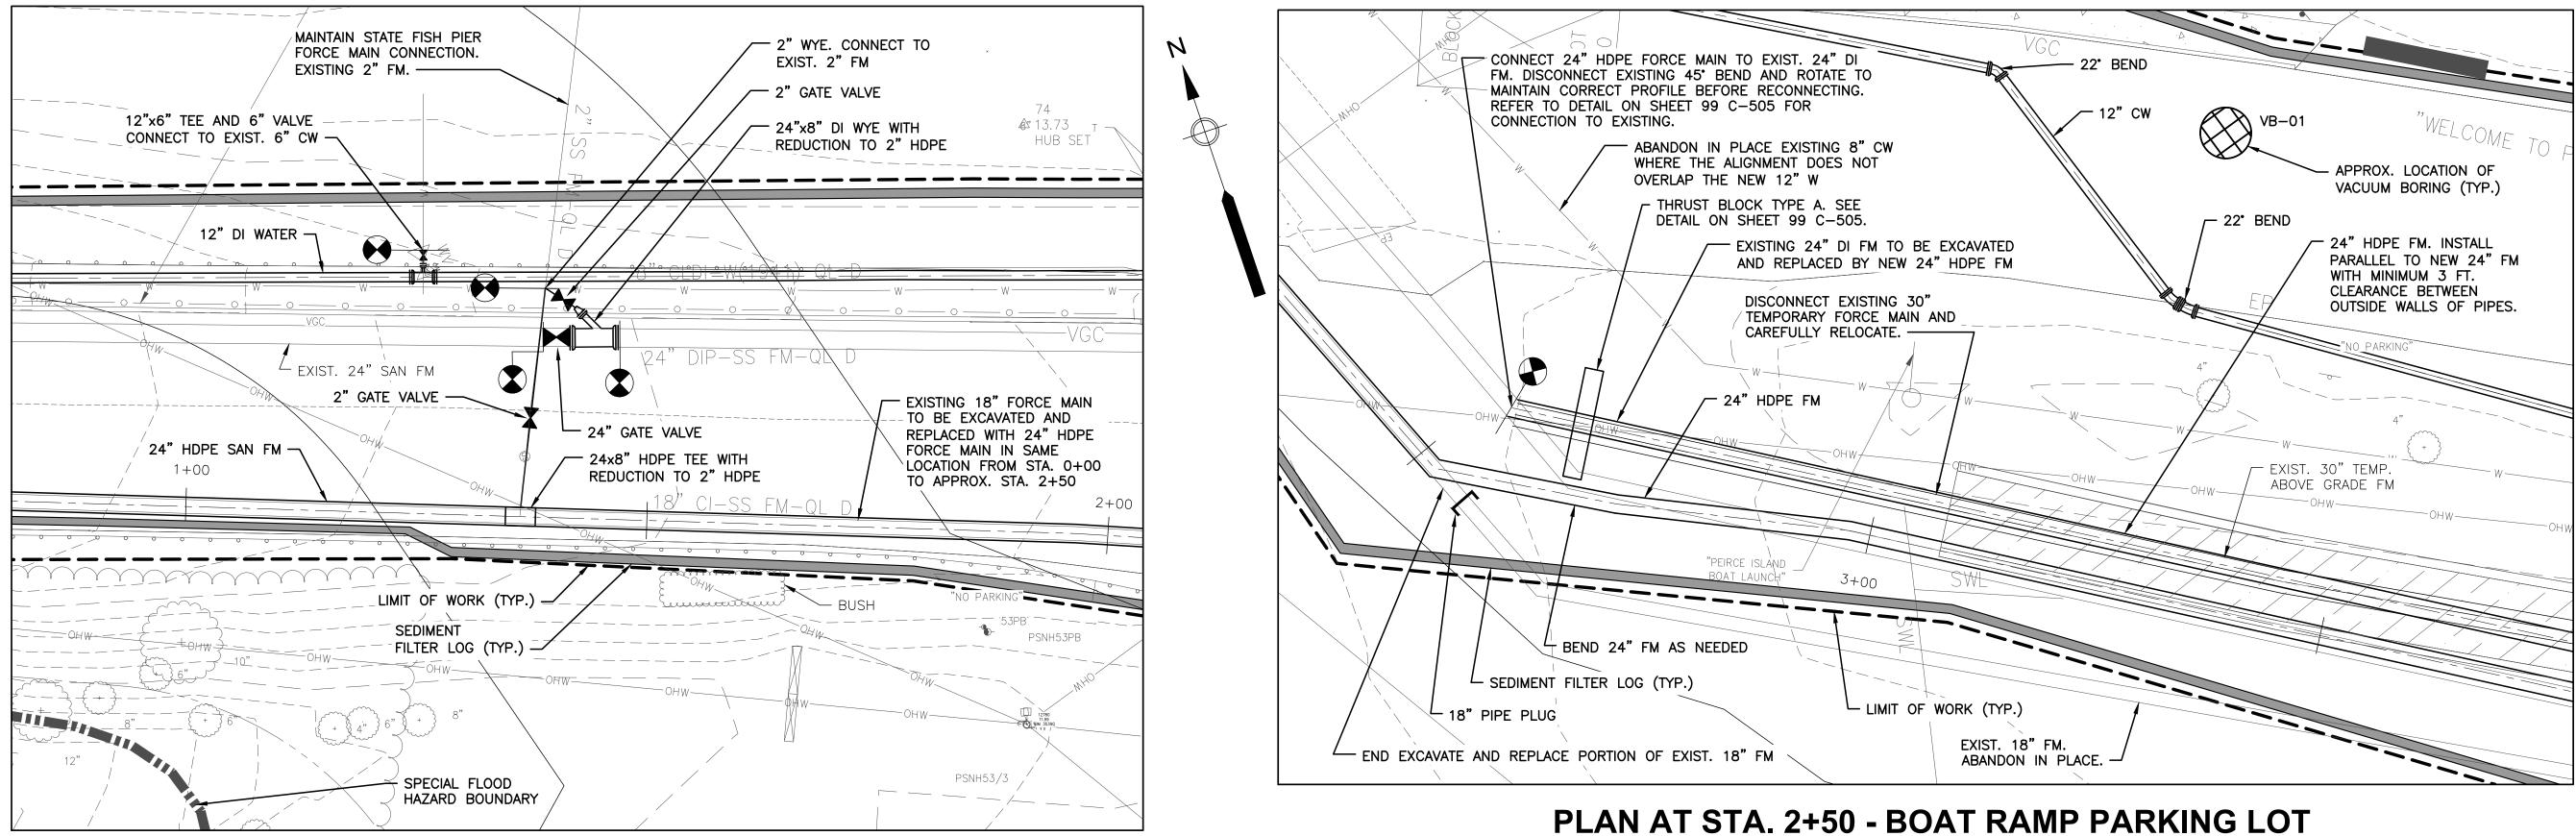

SCALE: 1"=10'

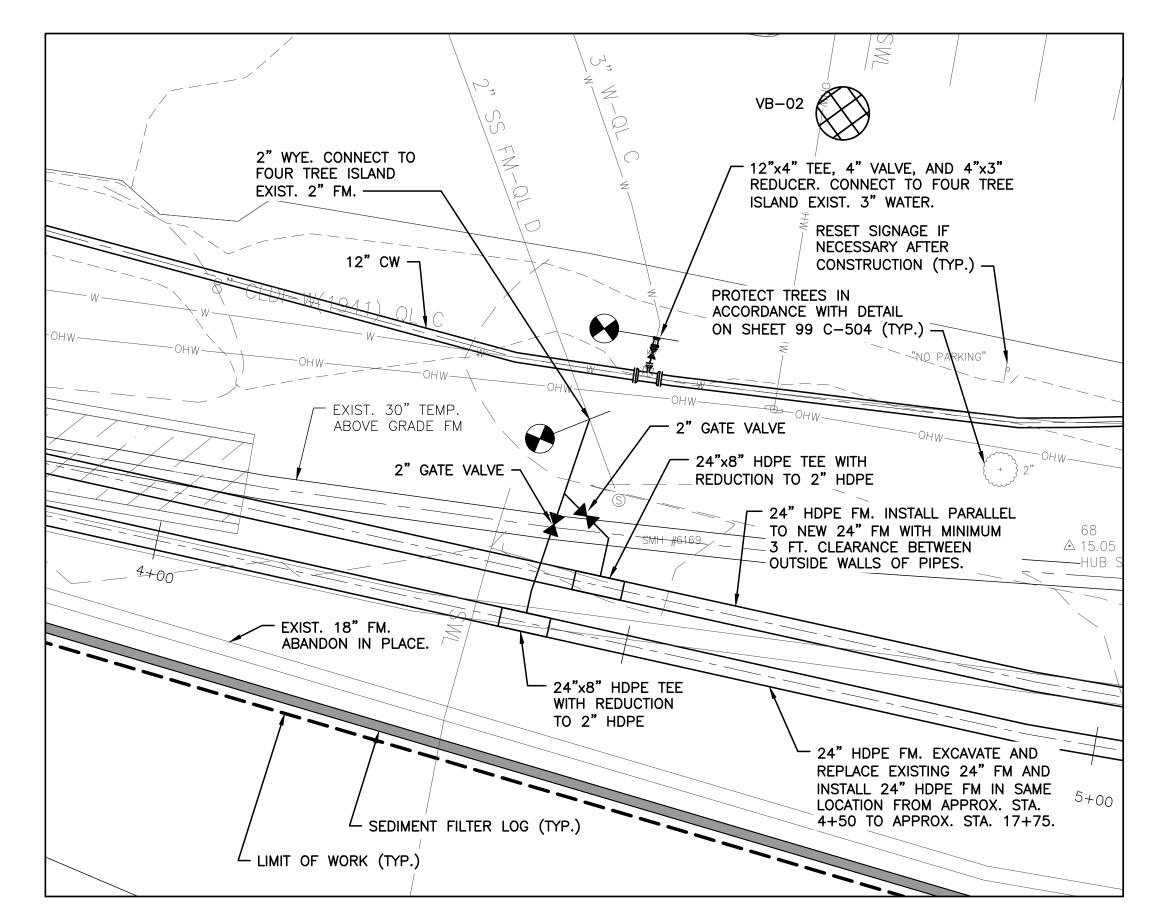

PLAN AT STA. 4+20 - FOUR TREE ISLAND

SCALE: 1"=10'

NOTES:

- 1. FOR LEGEND, ABBREVIATIONS AND GENERAL NOTES, SEE SHEET 00 C-001.
- 2. FOR DETAILS, SEE 99 SERIES OF CIVIL SHEETS.
- 3. MOVE SEDIMENT FILTER LOGS ON AND OFF ROAD DAILY AS NEEDED TO ALLOW TRAFFIC TO FLOW. ONE LANE OF ROAD TO REMAIN OPEN FOR TRAFFIC AT ALL TIMES.

AECOM

PROJECT

PEIRCE ISLAND FORCE MAIN AND WATER MAIN REPLACEMENT Peirce Island, Portsmouth NH

OWNER

CITY OF PORTSMOUTH **NEW HAMPSHIRE**

680 Peverly Hill Road Portsmouth, NH 03801

ENGINEER

www.aecom.com

AECOM TECHNICAL SERVICES, INC. 250 APOLLO DRIVE CHELMSFORD, MA 01824 PHONE: (978) 905-2100

REGISTRATION



ISSUE/REVISION

I/R	DATE	DESCRIPTION

PROJECT NUMBER

60649477

Designed By:	S. HE
Drawn By:	M. THIBODEAU
Dept Check:	C. BENZIGER
Proj Check:	E. MESERVE
Date:	AUGUST 2021
Scale:	AS NOTED

DISCIPLINE

CIVIL SHEET TITLE


ENLARGED PLANS I

SHEET NUMBER

00 C-108


PLAN AT STA. 1+50 - STATE FISH PIER

SCALE: 1"=10'

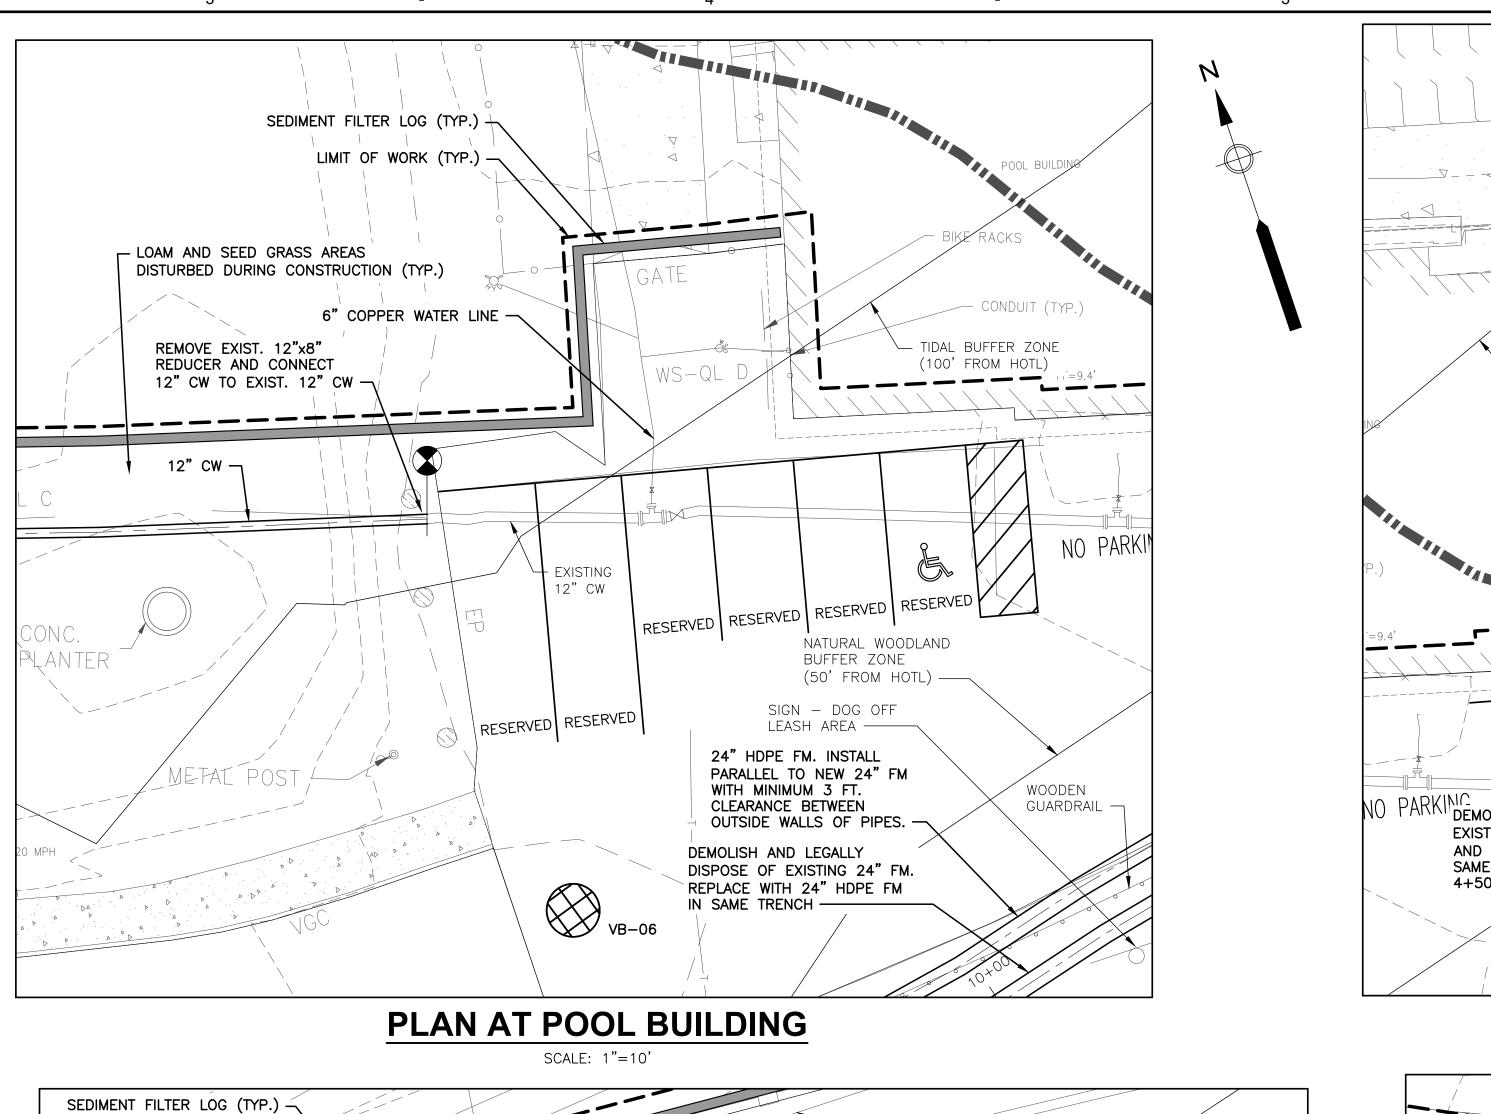


EXISTING EXISTING 24" HDPE FM. INSTALL SEWER MANHOLE PARALLEL TO NEW 24" FM SMH #5130 WITH MINIMUM 3 FT. SEDIMENT FILTER LOG (TYP.) CLEARANCE BETWEEN OUTSIDE WALLS OF PIPES. LIMIT OF WORK (TYP.) - TIDAL BUFFER ZONE (100' FROM HOTL) √ 6" GATE VALV POOL AND POOL PUMP STATION CONNECTIONS -EXISTING 2" FM EXISTING 12" CW SPECIAL FLOOD HAZARD BOUNDARY NATURAL WOODLAND BUFFER ZONE (50' FROM HOTL) -" WYE, CONNECT TO EXISTING 2" FM -24"x8" HDPE TEE 2" GATE RESET WOODEN WITH REDUCTION VALVE — GUARDRAIL DISTURBED TO 6" HDPE LOAM AND SEED GRASS DURING CONSTRUCTION AREAS DISTURBED DURING CONSTRUCTION (TYP.) -EXISTING 30" NO PARKING DEMOLISH AND LEGALLY DISPOSE OF TEMPORARY ABOVE GRADE FM EXISTING 24" FM. EXCAVATE, REMOVE AND REPLACE WITH 24" HDPE FM IN EXISTING 18" SAME TRENCH FROM APPROX. STA. ABANDONED IN PLACE 4+50 TO APPROX. STA. 17+75. — 24"x8" HDPE TEE WITH REDUCTION TO

PLAN AT STA. 11+10 - POOL CONNECTIONS

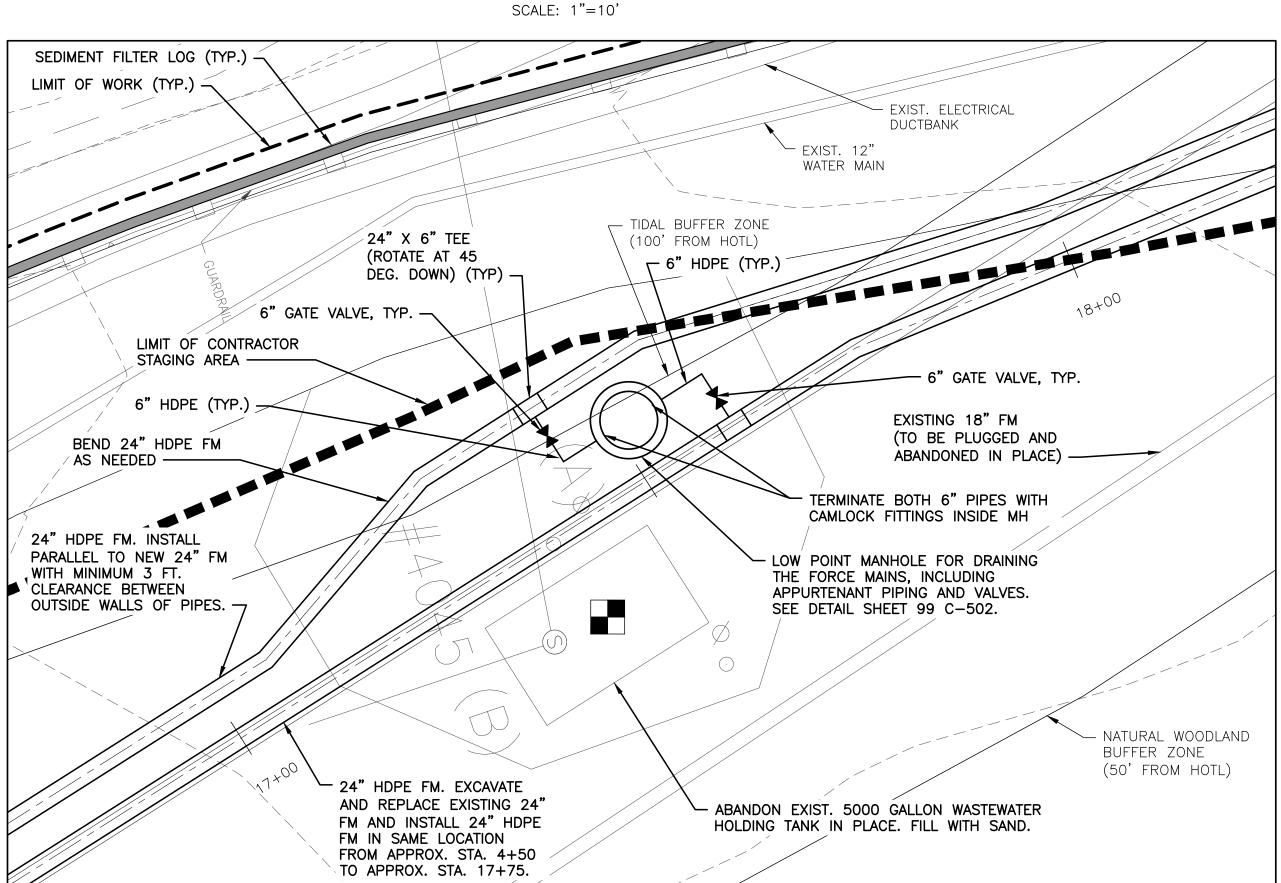

PLAN AT STA. 17+40 - BLOWOFF MANHOLE

SCALE: 1"=10'

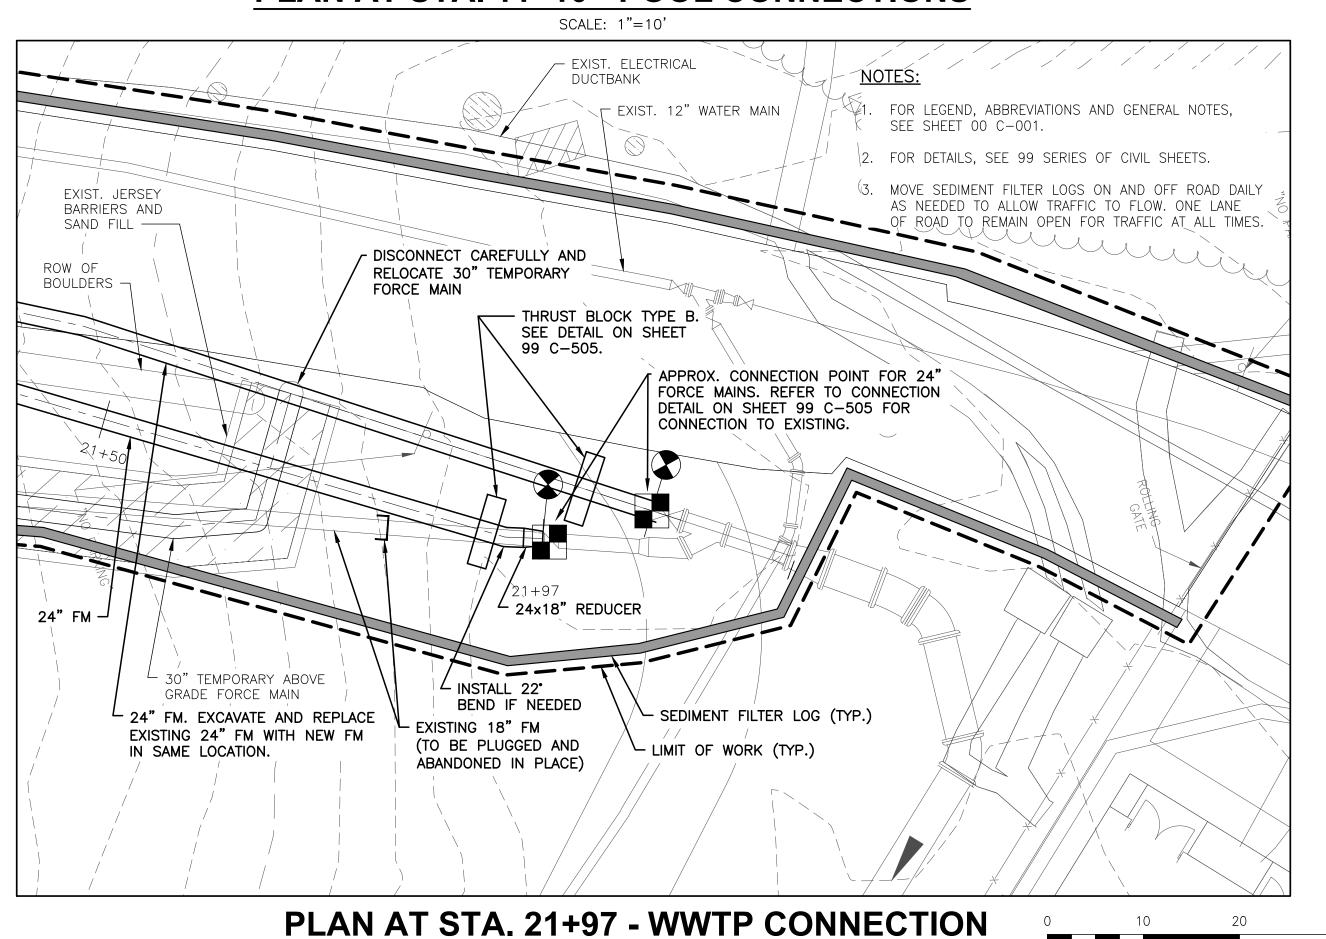

SCALE: 1"=10'

AECOM

PROJECT

PEIRCE ISLAND FORCE MAIN AND WATER MAIN REPLACEMENT

Peirce Island, Portsmouth NH

OWNER

CITY OF PORTSMOUTH NEW HAMPSHIRE

680 Peverly Hill Road Portsmouth, NH 03801

ENGINEER

AECOM TECHNICAL SERVICES, INC. 250 APOLLO DRIVE CHELMSFORD, MA 01824 PHONE: (978) 905-2100 www.aecom.com

REGISTRATION



ISSUE/REVISION

I/R	DATE	DESCRIPTION

PROJECT NUMBER

60649477

Designed By:	S. HE
Designed by.	3. IIL
Drawn By:	M. THIBODEAU
Dept Check:	C. BENZIGER
Proj Check:	E. MESERVE
Date:	AUGUST 2021
Scale:	AS NOTED

DISCIPLINE

CIVIL SHEET TITLE


ENLARGED PLANS II

SHEET NUMBER

00 C-109

SCALE

1" = 10'

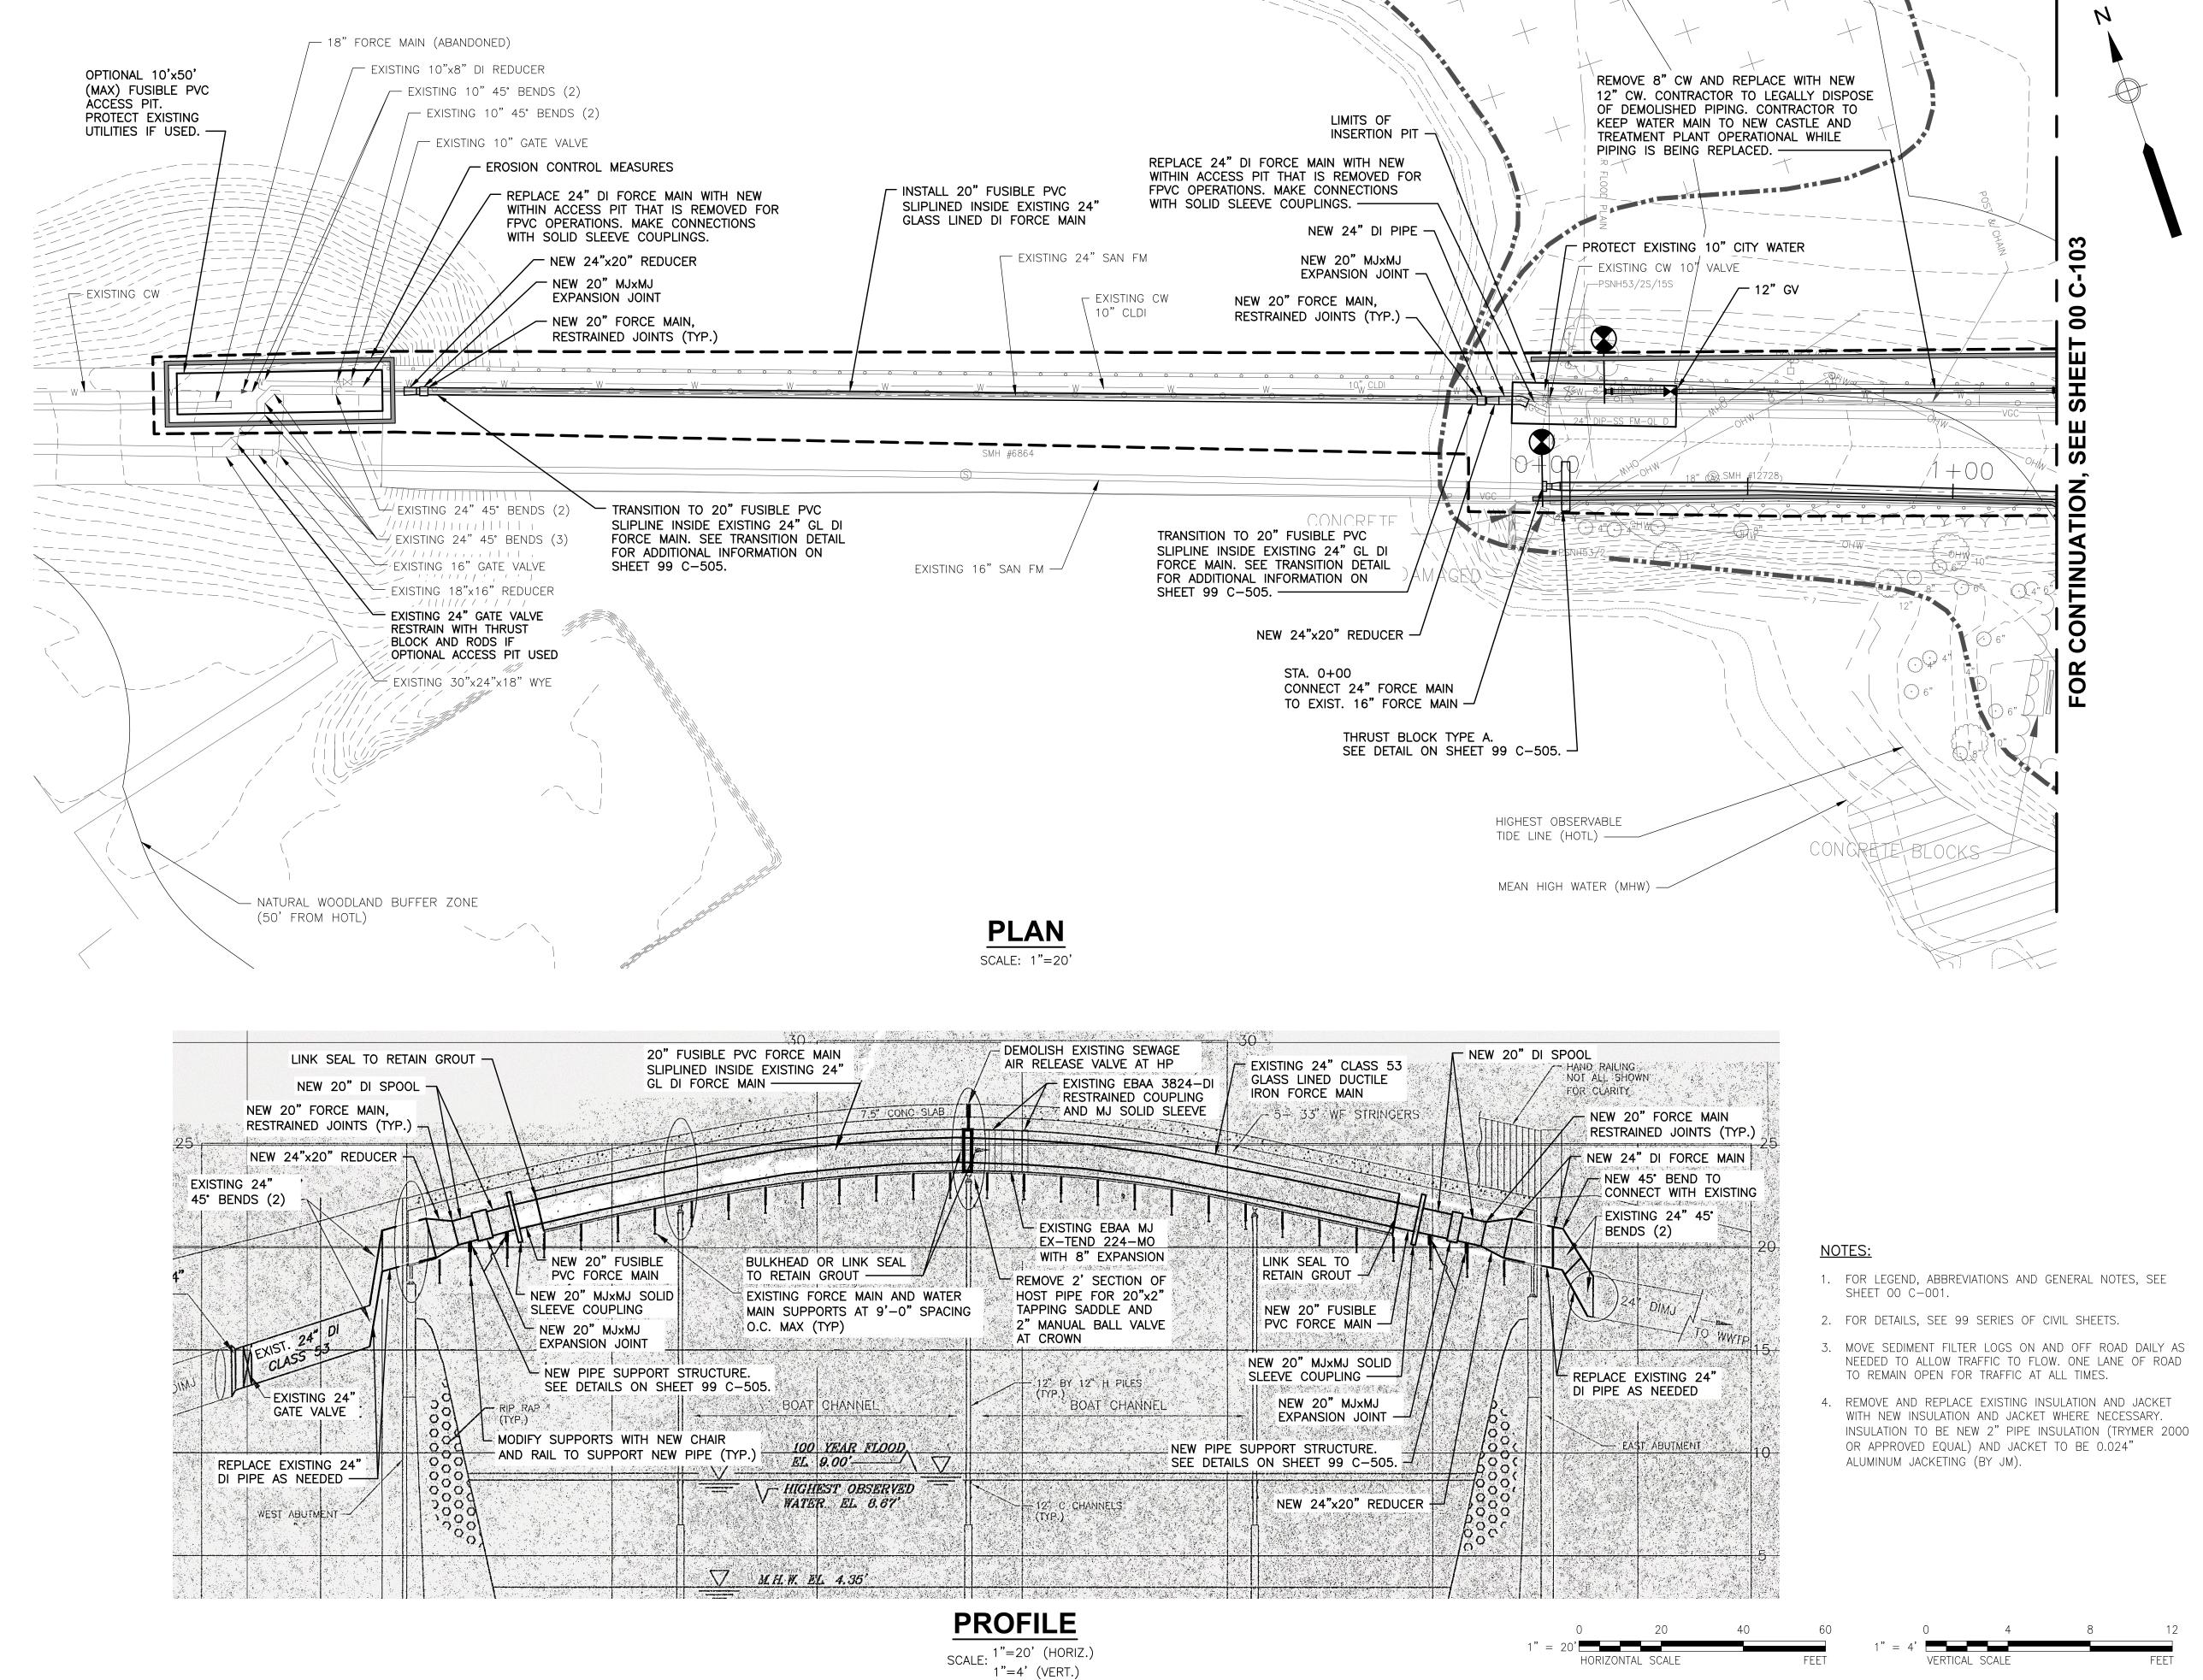

PROJECT

PEIRCE ISLAND
FORCE MAIN AND
WATER MAIN
REPLACEMENT
Peirce Island, Portsmouth NH

OWNER

CITY OF PORTSMOUTH NEW HAMPSHIRE

680 Peverly Hill Road Portsmouth, NH 03801

ENGINEER

AECOM TECHNICAL SERVICES, INC. 250 APOLLO DRIVE CHELMSFORD, MA 01824 PHONE: (978) 905-2100 www.aecom.com

REGISTRATION



ISSUE/REVISION

I/R	DATE	DESCRIPTION

PROJECT NUMBER

60649477

Designed By:	S. HE
Drawn By:	M. THIBODEAU
Dept Check:	C. BENZIGER
Proj Check:	E. MESERVE
Date:	AUGUST 2021
Scale:	AS NOTED


DISCIPLINE


CIVIL SHEET TITLE

PIPING PLAN AND PROFILE
PEIRCE ISLAND BRIDGE
SLIPLINING
SHEET NUMBER

STRAW BALE EROSION CONTROL

NTS 2-1.60.4 (REV. 09-29-95)

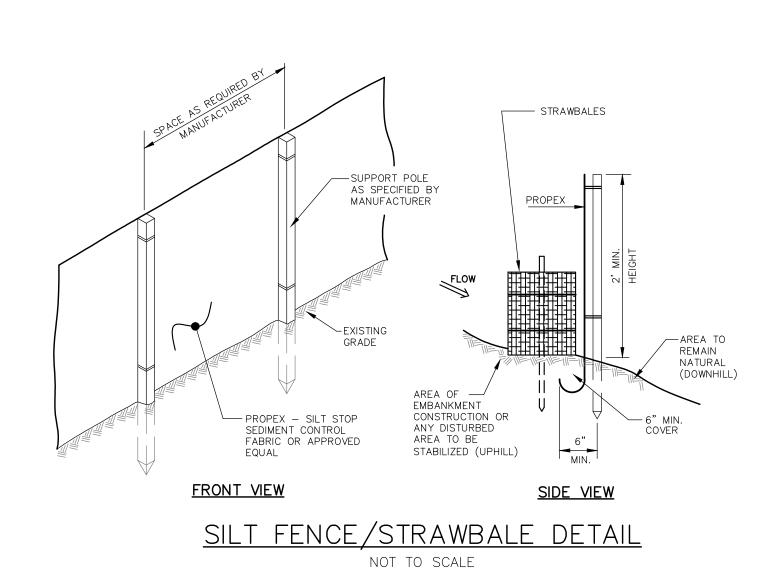


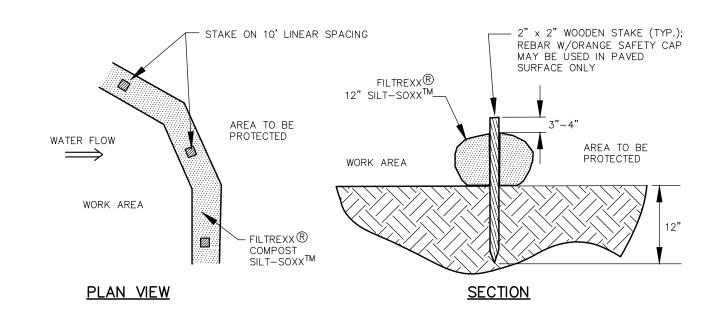

NOTES:


- 1. SILTSOXX MAY BY USED IN PLACE OF SILT FENCE OR OTHER SEDIMENT BARRIERS FOR AREAS OF REVETMENT CONSTRUCTION.
- 2. ALL MATERIAL TO MEET FILTREXX SPECIFICATIONS.
- 3. SILTSOXX COMPOST/SOIL/ROCK/SEED FILL MATERIAL SHALL BE ADJUSTED AS NECESSARY TO MEET THE REQUIREMENTS OF THE SPECIFIC APPLICATION.
- 4. ALL SEDIMENT TRAPPED BY SILTSOXX SHALL BE DISPOSED OF PROPERLY.

SEDIMENT FILTER LOG STAKING DETAIL

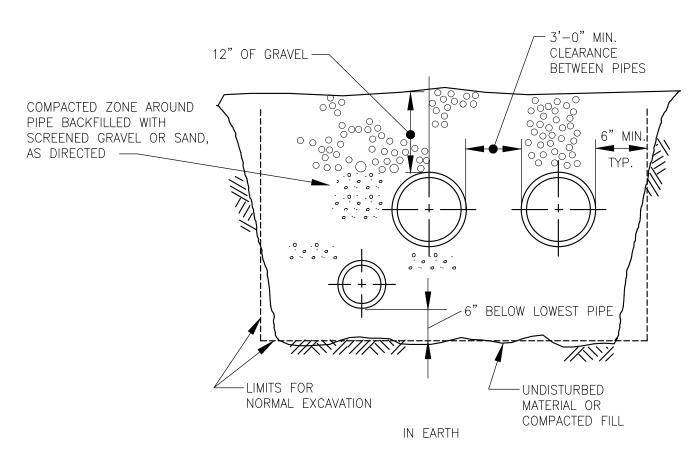


MULTIPLE PIPE TRENCH SECTION

NOT TO SCALE

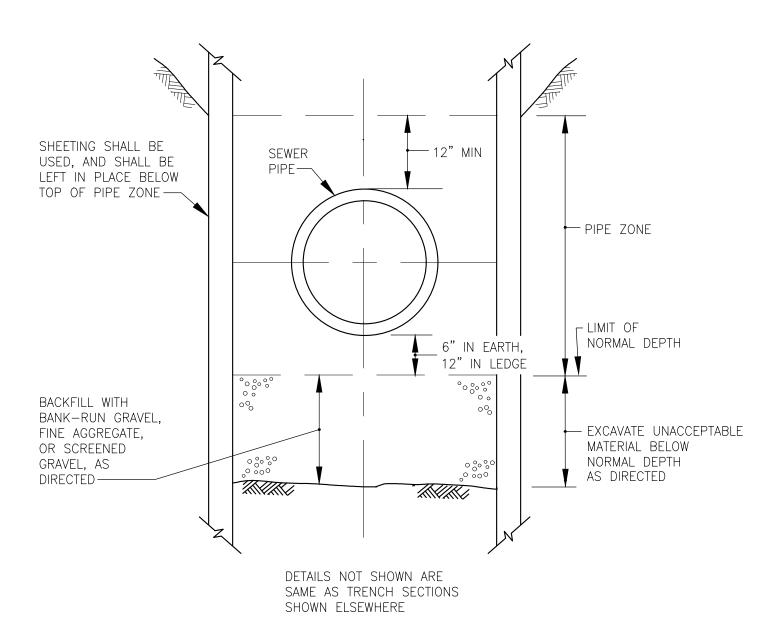


TRENCH SECTION IN UNACCEPTABLE MATERIAL

NOT TO SCALE 2-1.1.21 (REV. 03-15-95)

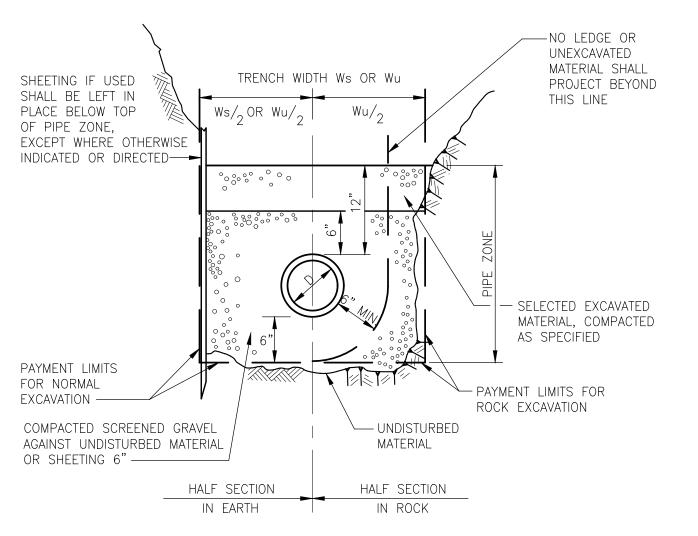

TRENCH SECTION FOR PIPE 18 INCH DIAMETER AND SMALLER NOT TO SCALE

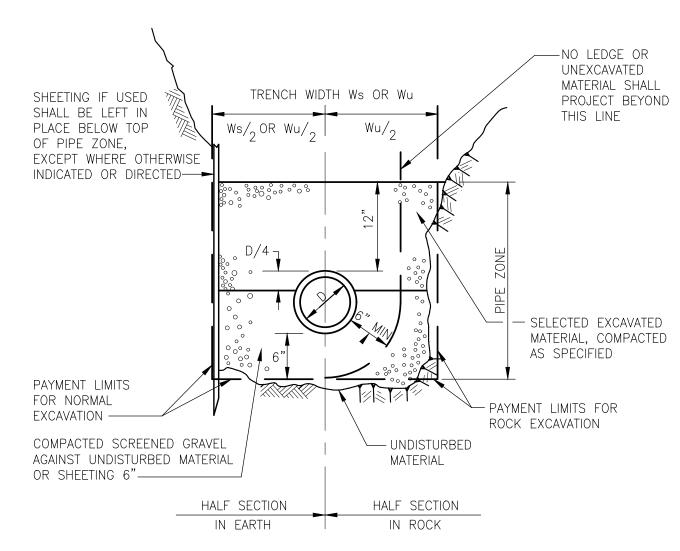

TRENCH SECTION FOR DI OR PVC PIPE ON INCH DIAMETER AND LARGER

NOT TO SCALE 2-1.1.2 (REV. 03-15-95)

TRENCH WI	OTH W	s OR V	Vu
NOMINAL PIPE DIAMETER		H OF PIPE IN GROUND SU	—
D	0 TO 12'	12' TO 20'	>20'
24" AND SMALLER	5'-0"	7'-0"	9'-0"
OVER 24"	D + 3' - 0"	D + 5'-0"	D + 7-0"
TWO 24"	2D + 6' - 0"	2D + 8'-0"	2D + 10-0"

- 1. PIPE TRENCHES MAY BE EXCAVATED WIDER THAN TRENCH WIDTH WS (SHEETED) OR Wu (UNSHEETED) ABOVE THE TOP OF PIPE ZONE.
- 2. TRENCHES SHALL NOT BE EXCAVATED BEYOND THE TRENCH WIDTH WU BELOW THE TOP OF PIPE ZONE.
- 3. SHEETING MUST BE USED IF EXCAVATION AND BACKFILL, BELOW NORMAL DEPTH, IS REQUIRED. SHEETING SHALL BE LEFT IN PLACE BELOW A LINE 1'-0" ABOVE THE TOP OF PIPE.

GENERAL NOTES FOR PIPE TRENCHES

NOT TO SCALE 2-1.1.11 (REV. 10-23-95)

AECOM

PROJECT

PEIRCE ISLAND
FORCE MAIN AND
WATER MAIN
REPLACEMENT
Peirce Island, Portsmouth NH

OWNER


CITY OF PORTSMOUTH NEW HAMPSHIRE

680 Peverly Hill Road Portsmouth, NH 03801

ENGINEER

AECOM TECHNICAL SERVICES, INC. 250 APOLLO DRIVE CHELMSFORD, MA 01824 PHONE: (978) 905-2100 www.aecom.com

REGISTRATION

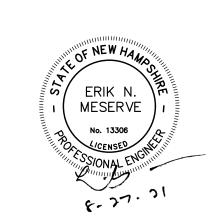

ISSUE/REVISION

ISSUL/INL VISION		
	_	
I/R	DATE	DESCRIPTION

PROJECT NUMBER

60649477


Designed By:	S. HE
Drawn By:	M. THIBODEAU
Dept Check:	C. BENZIGER
Proj Check:	E. MESERVE
Date:	AUGUST 2021
Scale:	AS NOTED

DISCIPLINE

CIVIL SHEET TITLE

DETAILS I

SHEET NUMBER

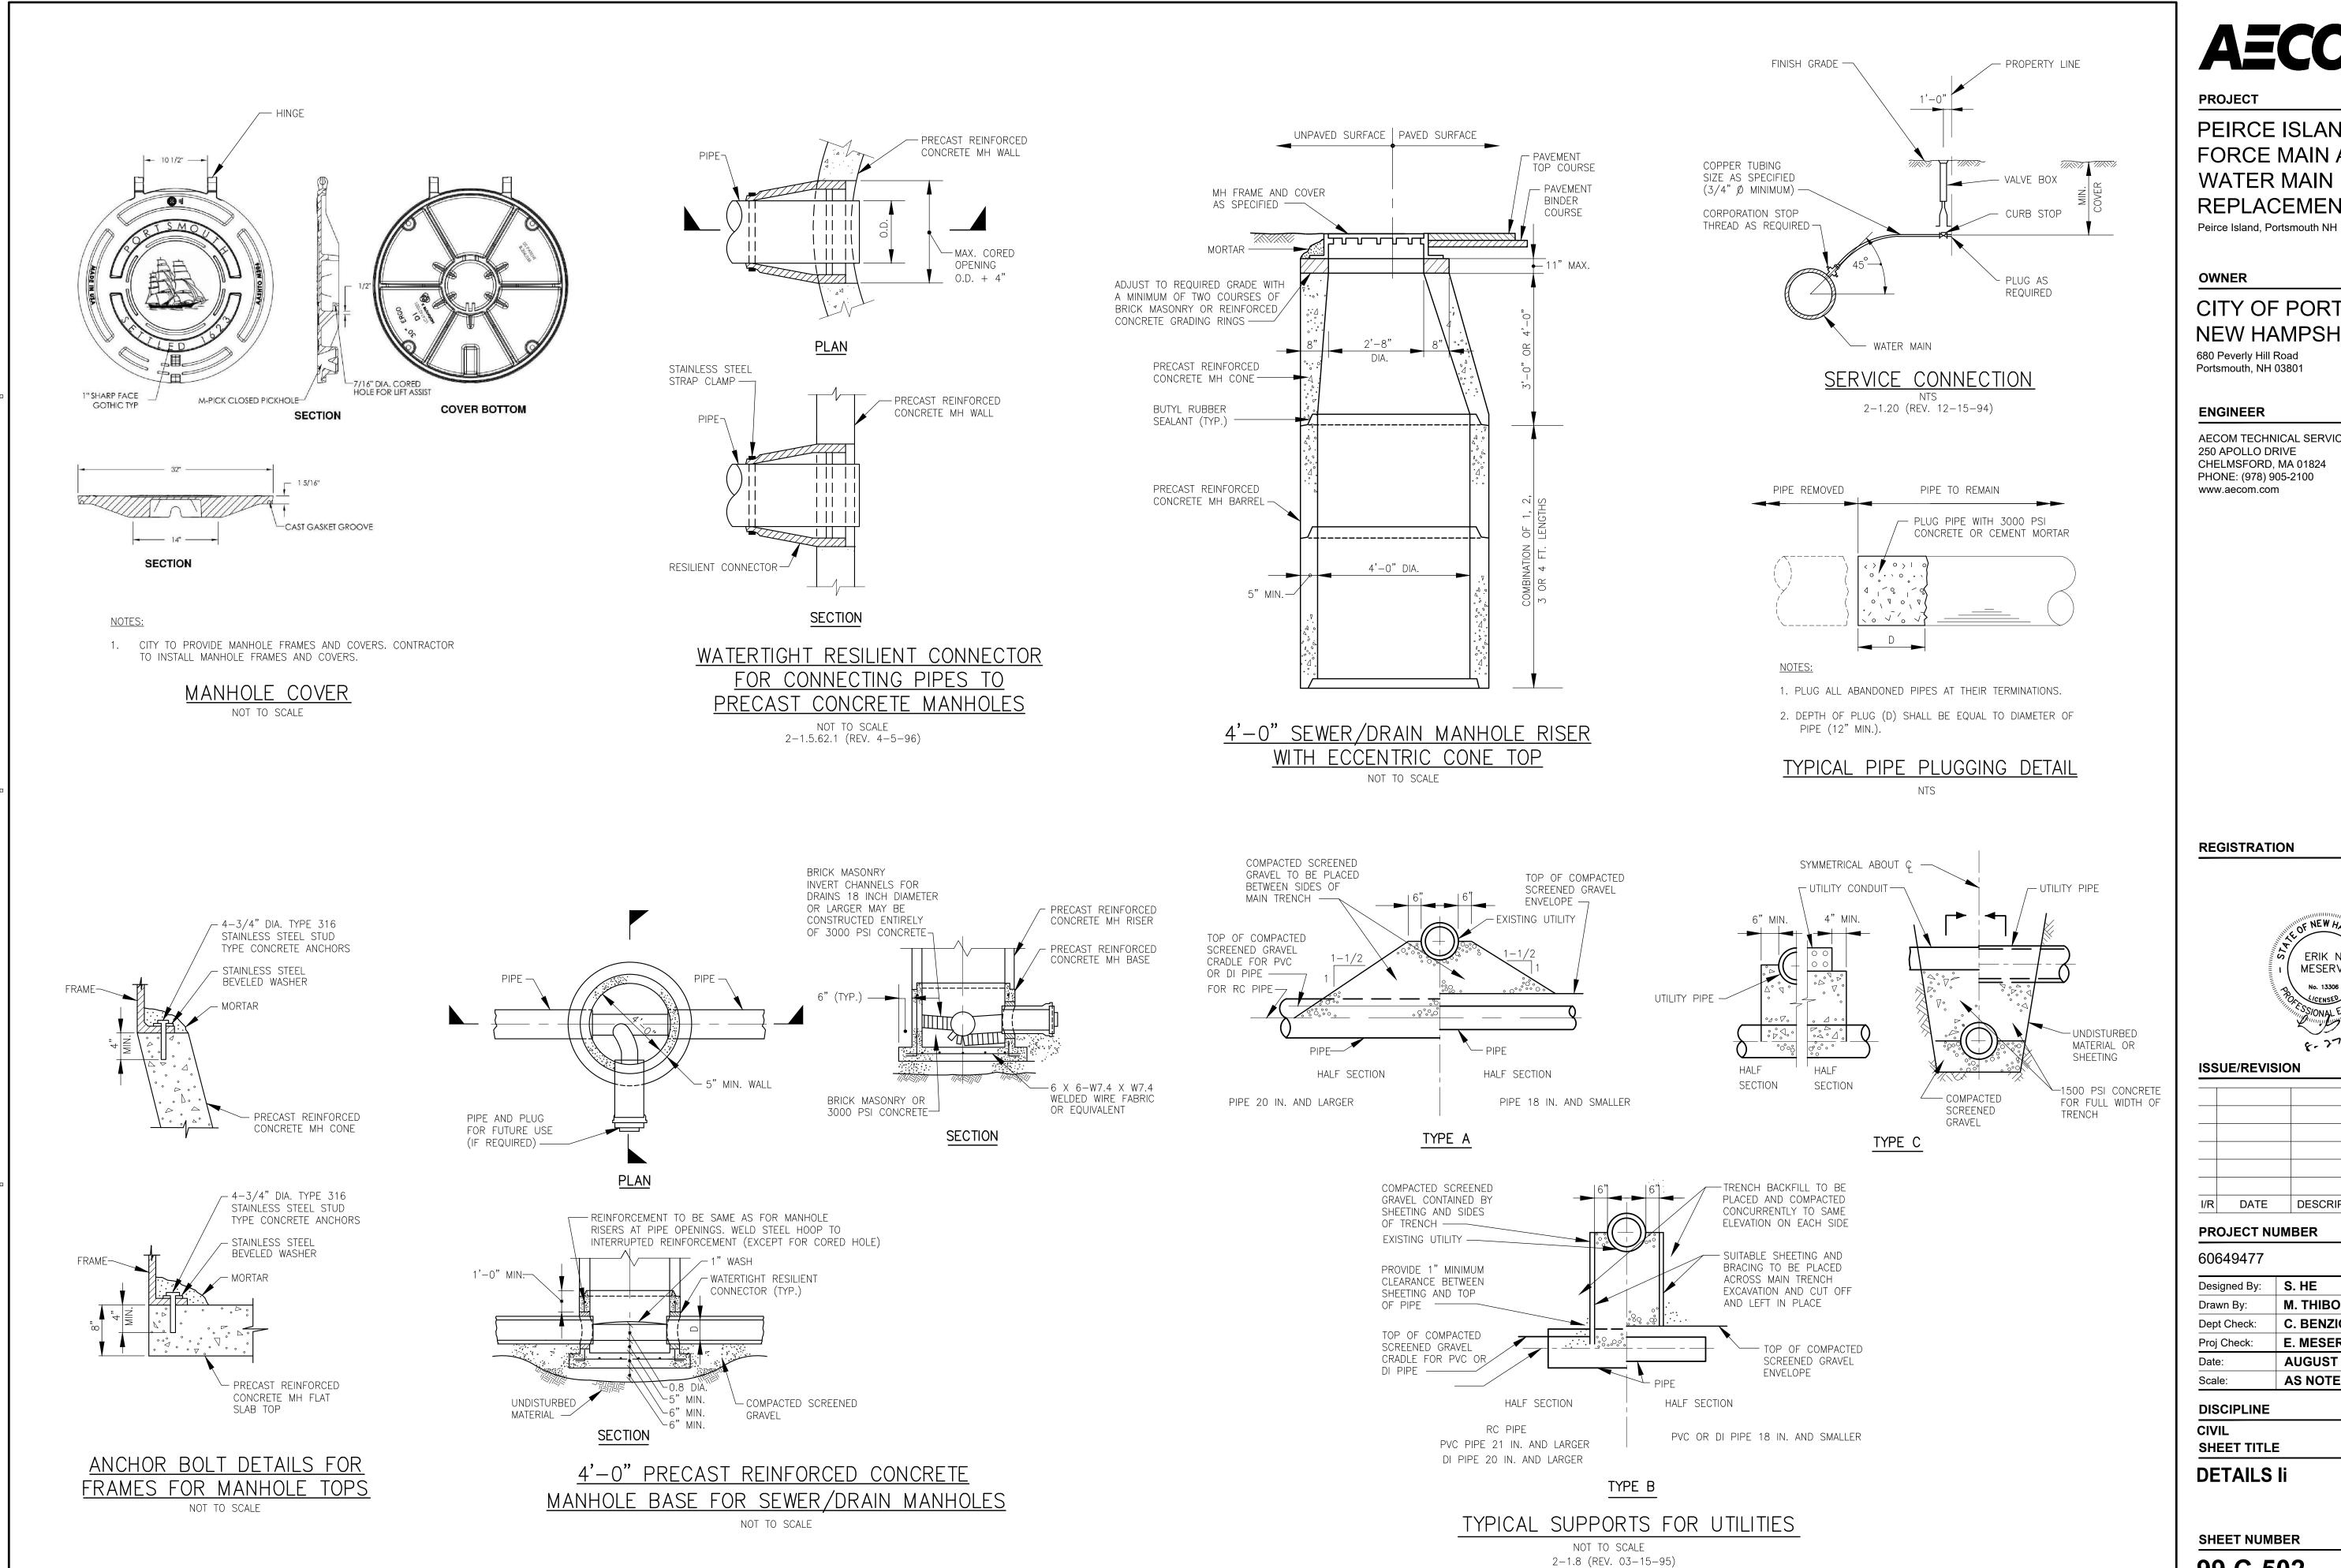

PEIRCE ISLAND FORCE MAIN AND **WATER MAIN** REPLACEMENT

CITY OF PORTSMOUTH **NEW HAMPSHIRE**

680 Peverly Hill Road Portsmouth, NH 03801

AECOM TECHNICAL SERVICES, INC. 250 APOLLO DRIVE CHELMSFORD, MA 01824 PHONE: (978) 905-2100 www.aecom.com

REGISTRATION



ISSUE/REVISION

I/R DATE DESCRIPTION

PROJECT NUMBER

60649477


Designed By:	S. HE
Drawn By:	M. THIBODEAU
Dept Check:	C. BENZIGER
Proj Check:	E. MESERVE
Date:	AUGUST 2021
Scale:	AS NOTED

DISCIPLINE

SHEET TITLE

DETAILS II

SHEET NUMBER

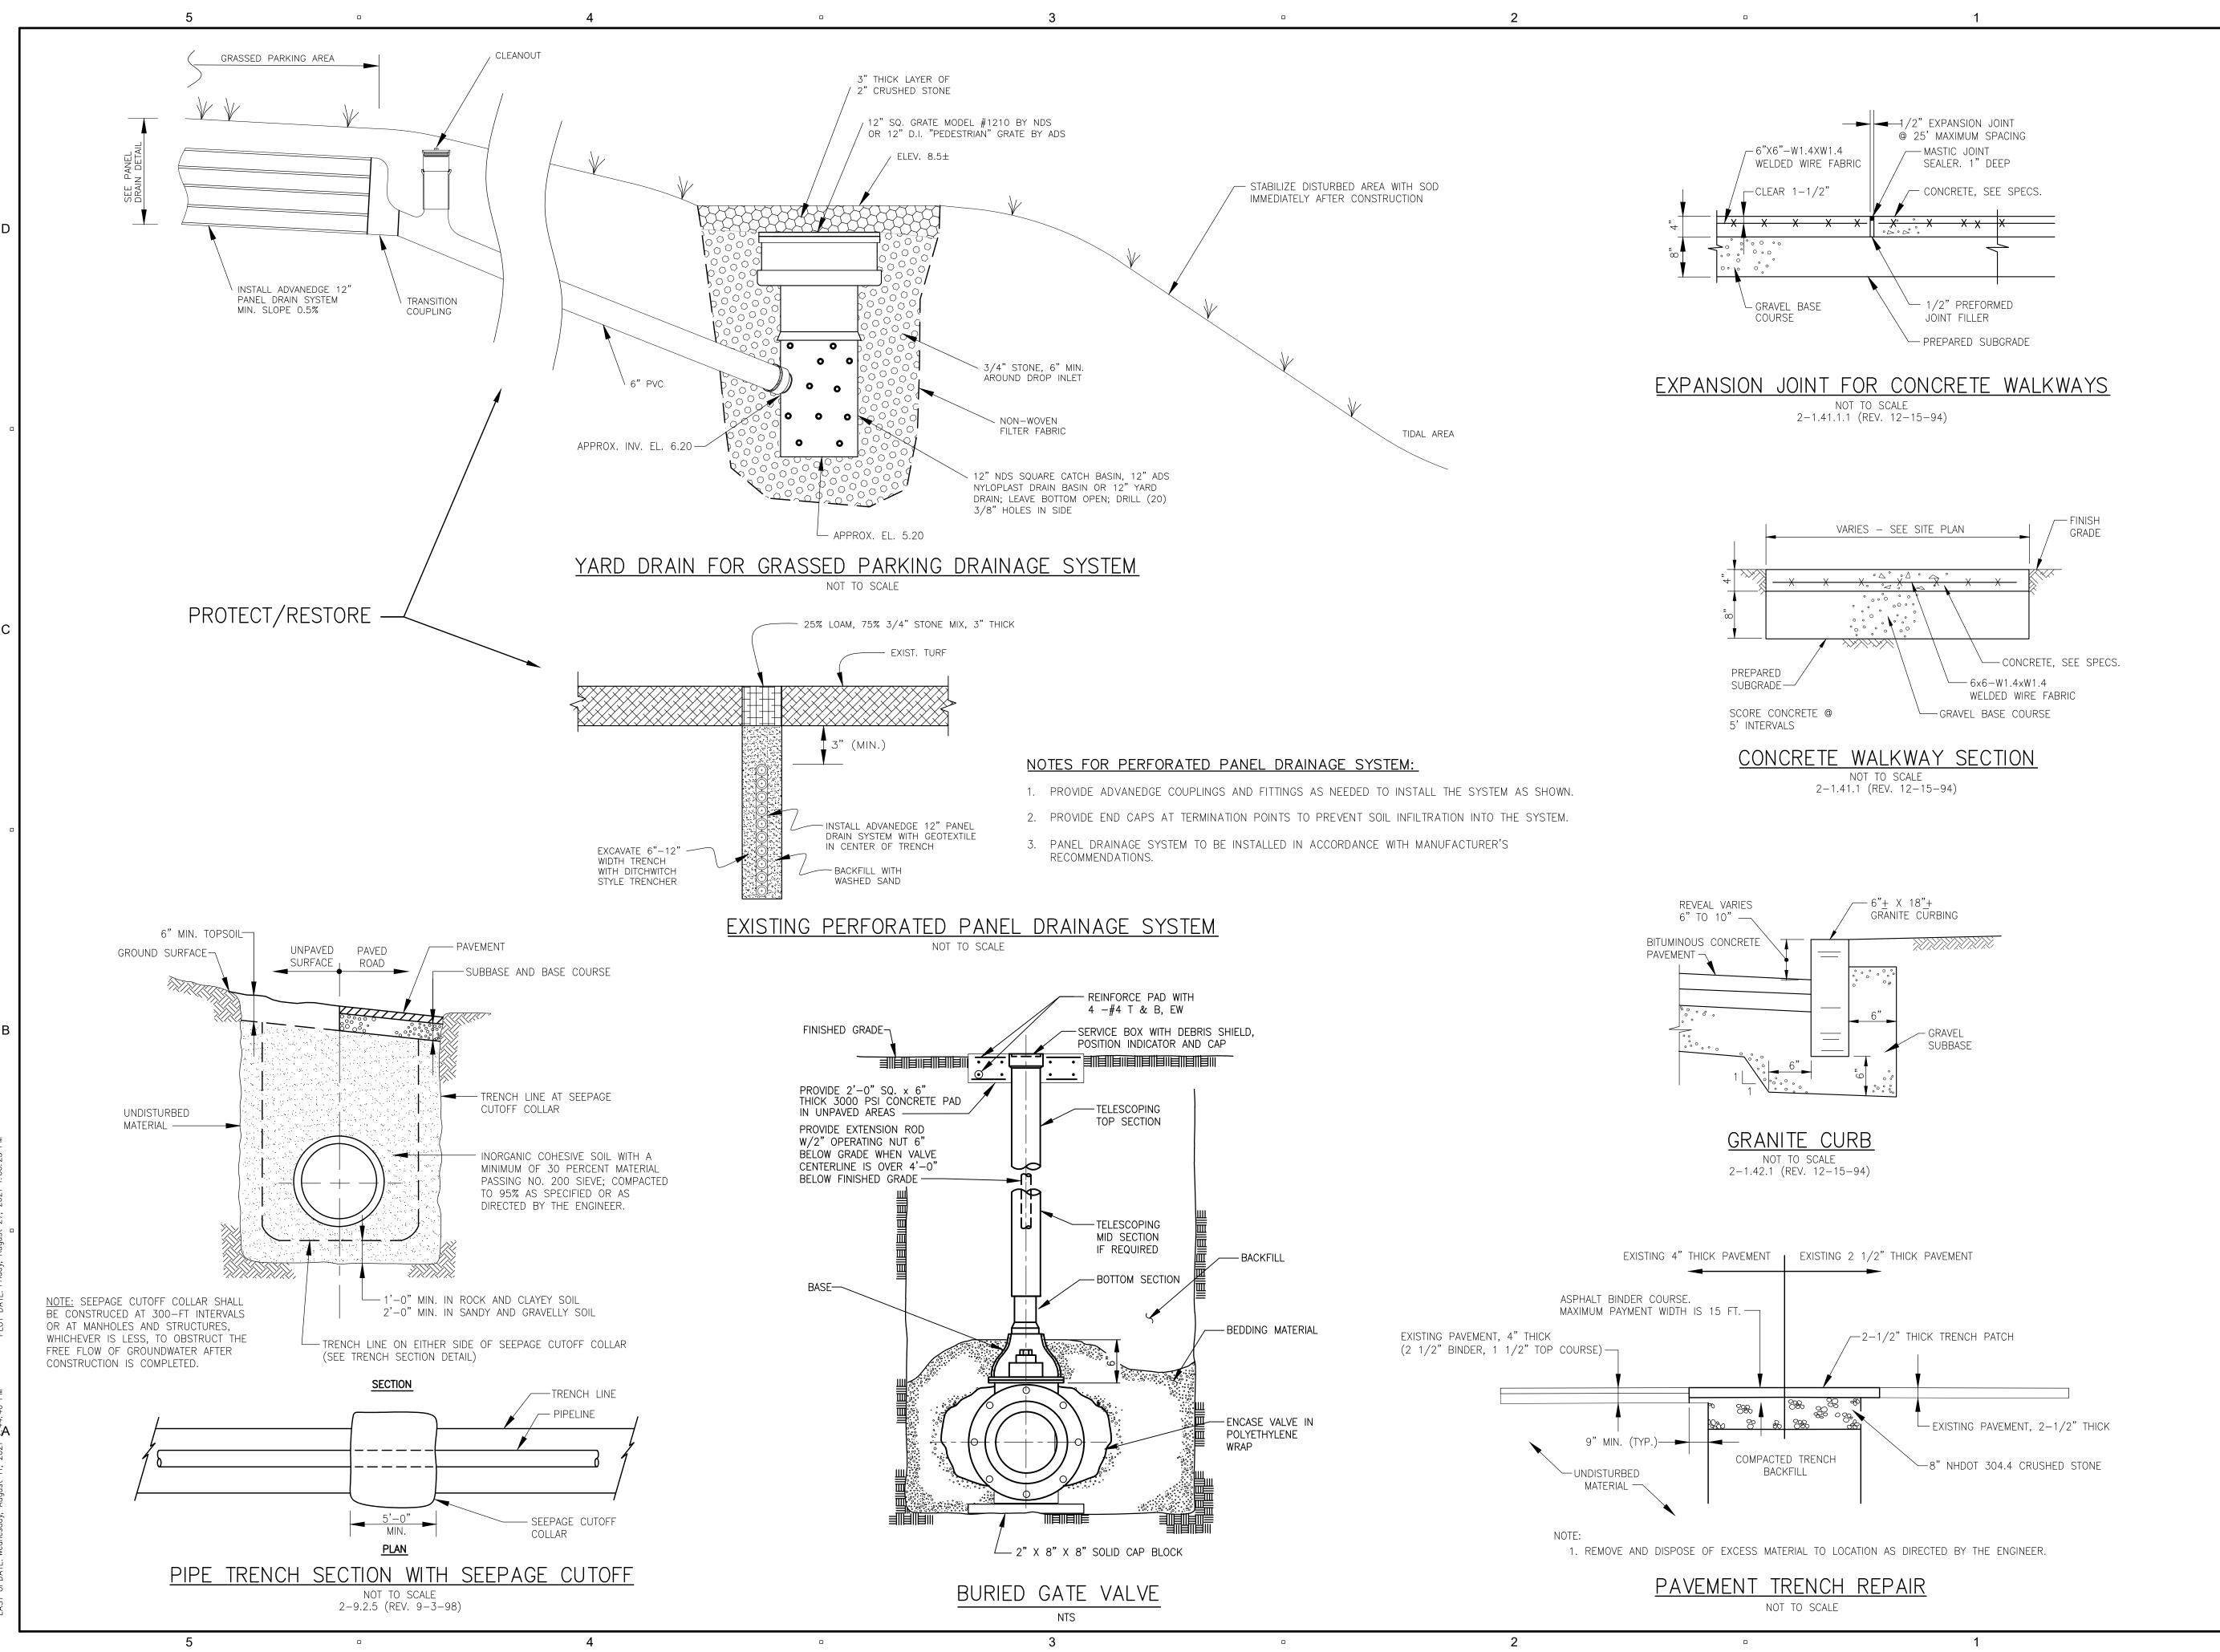

PROJECT

PEIRCE ISLAND
FORCE MAIN AND
WATER MAIN
REPLACEMENT
Peirce Island, Portsmouth NH

OWNER

CITY OF PORTSMOUTH NEW HAMPSHIRE

680 Peverly Hill Road Portsmouth, NH 03801

ENGINEER

AECOM TECHNICAL SERVICES, INC. 250 APOLLO DRIVE CHELMSFORD, MA 01824 PHONE: (978) 905-2100 www.aecom.com

REGISTRATION



ISSUE/REVISION

I/R	DATE	DESCRIPTION

PROJECT NUMBER

60649477

Designed By:	S. HE
Drawn By:	M. THIBODEAU
Dept Check:	C. BENZIGER
Proj Check:	E. MESERVE
Date:	AUGUST 2021
Scale:	AS NOTED


DISCIPLINE

CIVIL SHEET TITLE

DETAILS III


99 C-503

SHEET NUMBER

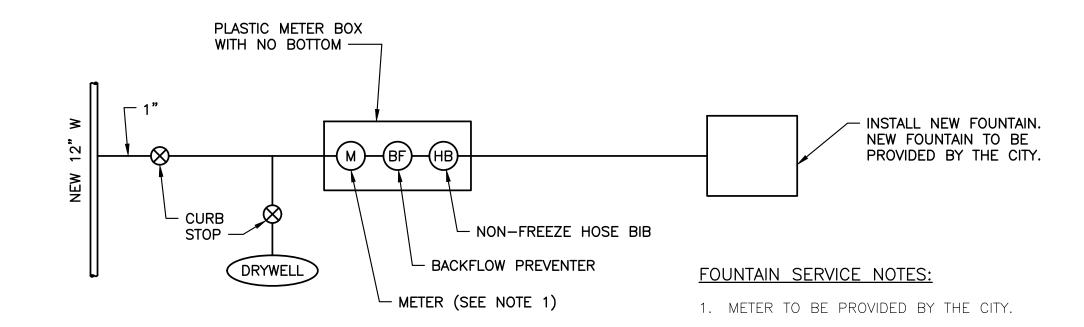

FOUNTAIN SERVICE CONNECTION SCHEMATIC

SCALE: NONE

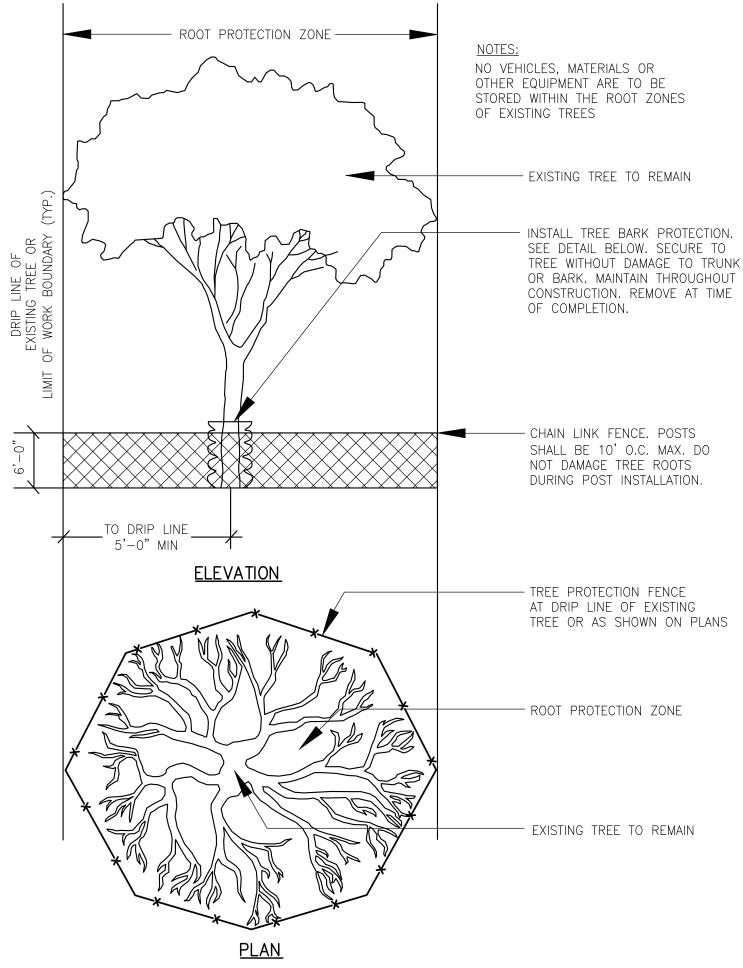


NOTES:

1. THIS DETAIL APPLIES FOR THE PROTECTION OF ALL TREES WITHIN LIMIT OF WORK.

2. NO VEHICLES, MATERIALS OR OTHER EQUIPMENT ARE TO BE STORED WITHIN THE ROOT ZONES OF EXISTING TREES.

TREE PROTECTION

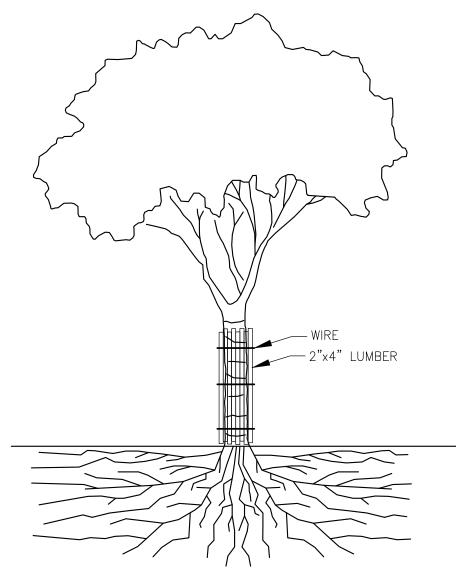

OTES:

1. THIS DETAIL APPLIES FOR THE PROTECTION OF ALL TREES WITHIN LIMIT OF WORK.


2. IN SITUATIONS WHERE A PROTECTED TREE REMAINS IN THE IMMEDIATE AREA OF INTENDED CONSTRUCTION AND THE TREE MAY BE IN DANGER OF BEING DAMAGED BY CONSTRUCTION EQUIPMENT OR OTHER ACTIVITY, THE CONTRACTOR OR SUBCONTRACTOR SHALL PROTECT THE TREE WITH 2"x4" LUMBER ENCIRCLED WITH WIRE OR OTHER MEANS THAT DO NOT DAMAGE THE TREE. THE INTENT IS TO PROTECT THE TRUNK OF THE TREE AGAINST INCIDENTAL CONTACT BY LARGE CONSTRUCTION EQUIPMENT.

TREE BARK PROTECTION

NTS

LANDSCAPING NOTES:

- 1. THE CONTRACTOR SHALL LOCATE AND VERIFY ALL UTILITIES PRIOR TO STARTING WORK. CONTRACTOR TO VERIFY THAT ADEQUATE DRAINAGE EXISTS PRIOR TO PLANTING.
- 2. ALL MATERIAL SHALL CONFORM TO THE GUIDELINES ESTABLISHED BY THE "AMERICAN STANDARD FOR NURSERY STOCK", PUBLISHED BY THE AMERICAN ASSOCIATION OF NURSERYMEN.
- 3. ALL PLANT MATERIALS ARE SUBJECT TO THE APPROVAL OF THE ENGINEER AT THE NURSERY AND AT THE SITE. ALL TREES SHALL HAVE A SINGLE LEADER UNLESS SPECIFIED OTHERWISE. NO UN-APPROVED SUBSTITUTIONS WILL BE ACCEPTED. PLANT SPECIES AND CULTIVAR, SIZE AND QUANTITY SHALL NOT CHANGE WITHOUT APPROVAL OF LANDSCAPE ARCHITECT.
- 4. LOCATION OF ALL TREES AND SHRUBS SHALL BE MARKED FOR THE APPROVAL OF THE PROJECT ENGINEER. MARKING SHALL BE COMPLETED THE DAY PRIOR TO COMMENCEMENT OF PLANTING.
- 5. ALL PLANTS SHALL BEAR THE SAME RELATIONSHIP TO FINISHED GRADE AS ORIGINAL GRADE BEFORE DIGGING. PLANT TO BE TRANSPLANTED SHALL BE DUG CAREFULLY, WITH ADEQUATE ROOT—BALLS AND PRUNED ACCORDING TO ANA STANDARD PRACTICE. TREES WITH ROOT FLARE COVERED BY MORE THAN 1.5" OF SOIL WILL BE REJECTED PRIOR TO INSTALLATION. SET PLANTS PLUMB.
- 6. ALL TREES AND SHRUBS SHALL BE BALLED IN BURLAP OR CONTAINERIZED, UNLESS SPECIFIED OTHERWISE. NO ROOT—BOUND CONTAINER GROWN STOCK WILL BE ACCEPTED. ALL PLASTIC ROOT WRAPPING AND METAL WIRE BASKETS SHALL BE CAREFULLY REMOVED AT THE TIME OF PLANTINGS, EXCEPT WIRE THAT IS DIRECTLY UNDER THE ROOT—BALLS.
- 7. AFTER CONDUCTING SOIL TESTS WITHIN PLANTING AREAS, THE CONTRACTOR IS RESPONSIBLE FOR PROVIDING PLANTING TOPSOIL AND/OR AMENDMENTS FOR BACKFILLING AT ALL PLANTS, AS NECESSARY. SUBMIT WRITTEN CONTENT ANALYSIS TO OWNER/REP. FOR APPROVAL. ADD 'PHC HEALTHY START 3-4-3' AND 'MYCOR TREE OR PLANT SAVER 4-7-4', OR EQUAL. FOLLOW MANUFACTURER'S GUIDELINES. THE PLANTING TOPSOIL IS TO BE SANDY LOAM MODIFIED WITH ORGANIC COMPONENT TO HAVE AT LEAST 4% ORGANIC MATTER BUT NOT MORE THAN 8% ORGANIC MATTER, DRY WEIGHT BASIS, A COMPACTED MINIMUM INFILTRATION RATE OF 2.5 CM/HR, PH RANGE OF 5.5 TO 6.5, AND NO COARSE FRAGMENTS OVER 2.5 CM IN SIZE.
- 8. CONTRACTOR SHALL PLACE 2" TO 3" OF FINE SHREDDED, AGED 2 YEARS, DARK BROWN PINE BARK MULCH THROUGHOUT THE BED AREAS. DO NOT PLACE MULCH IN CONTACT WITH TREE TRUNK. SUBMIT SAMPLE OF MULCH FOR APPROVAL.
- 9. ALL EVERGREEN PLANTS SHALL BE SPRAYED WITH AN ANTI-DESICCANT THE FIRST WEEK OF NOVEMBER, THE FIRST WINTER FOLLOWING PLANTING.
- 10. FLOOD PLANTS THOROUGHLY ONCE IMMEDIATELY AFTER PLANTING AND TWICE DURING THE FIRST TWENTY-FOUR HOUR PERIOD AFTER PLANTING.
- 11. EXTREME CARE SHALL BE TAKEN NOT TO DISTURB EXISTING PLANT MATERIALS. ANY PLANT INJURED OR DESTROYED SHALL BE REPLACED WITH A PLANT OF EQUAL OR GREATER SIZE AND SPECIES AT THE CONTRACTORS EXPENSE.
- 12. IF NECESSARY, NEW PLANTING SHOULD BE PLACED OUTSIDE OF THE CRITICAL ROOT ZONE (CRZ) OF EXISTING TREES. CRZ RADIUS EQUALS ONE—FOOT TIMES THE DBH (DIAMETER—AT—BREAST—HEIGHT) OF THE TREES, MEASURED FROM THE TREE TRUNK. TREE FENCING IS NECESSARY TO PROTECT EXISTING VEGETATION TO BE PRESERVED FROM BOTH FOOT AND VEHICULAR TRAFFIC. TREE FENCING TO BE LOCATED AT THE EDGE OF THE CRZ.
- 13. DO NOT WRAP TRUNK OF TREE.
- 14. THE CONTRACTOR SHALL MAINTAIN THE PLANTS FOR A MINIMUM OF 90 DAYS FOLLOWING INSTALLATION, OR LONGER IF CONTRACTED BY THE OWNER. BEFORE THE END OF THE 90—DAY PERIOD, THE CONTRACTOR SHALL PROVIDE A WRITTEN MAINTENANCE OUTLINES TO THE OWNERS AND THE CONTRACTOR SHALL BE AVAILABLE TO ANSWER QUESTIONS OR CONCERNS AT THAT TIME.
- 15. THE CONTRACTOR SHALL GUARANTEE ALL PLANTS FOR A MINIMUM OF ONE YEAR FROM FINAL ACCEPTANCE BY OWNER/REP. THE CONTRACTOR SHALL REPLACE ANY DEAD MATERIALS AT HIS/HER OWN EXPENSE.

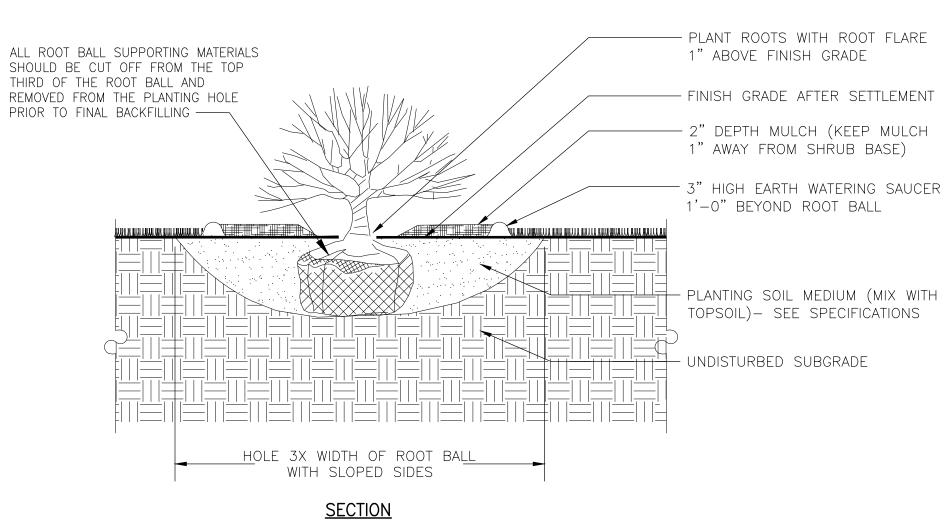

NOTES:

- 1. SCARIFY SOILS CONTINUOUSLY TO A DEPTH OF 4" AT INTERFACE BETWEEN SOIL TYPES AND LIFTS TO PROMOTE BLENDING OF SOILS.
- 2. SEE SHEET 00 C-107 FOR PLANT LIST AND PLAN FOR SPACING.
- 3. ALL PLANTING TO BE DONE AS PER ANSI A300 (PART 6) 2012.

SHRUB PLANTING

NOT TO SCALE

AECON

PROJECT

PEIRCE ISLAND FORCE MAIN AND WATER MAIN REPLACEMENT

Peirce Island, Portsmouth NH

OWNER

CITY OF PORTSMOUTH NEW HAMPSHIRE

680 Peverly Hill Road Portsmouth, NH 03801

ENGINEER

AECOM TECHNICAL SERVICES, INC. 250 APOLLO DRIVE CHELMSFORD, MA 01824 PHONE: (978) 905-2100 www.aecom.com

REGISTRATION



ISSUE/REVISION

I/R	DATE	DESCRIPTION
		·

PROJECT NUMBER

60649477


Designed By:	S. HE
Drawn By:	M. THIBODEAU
Dept Check:	C. BENZIGER
Proj Check:	E. MESERVE
Date:	AUGUST 2021
Scale:	AS NOTED

DISCIPLINE

CIVIL SHEET TITLE

DETAILS IV

SHEET NUMBER

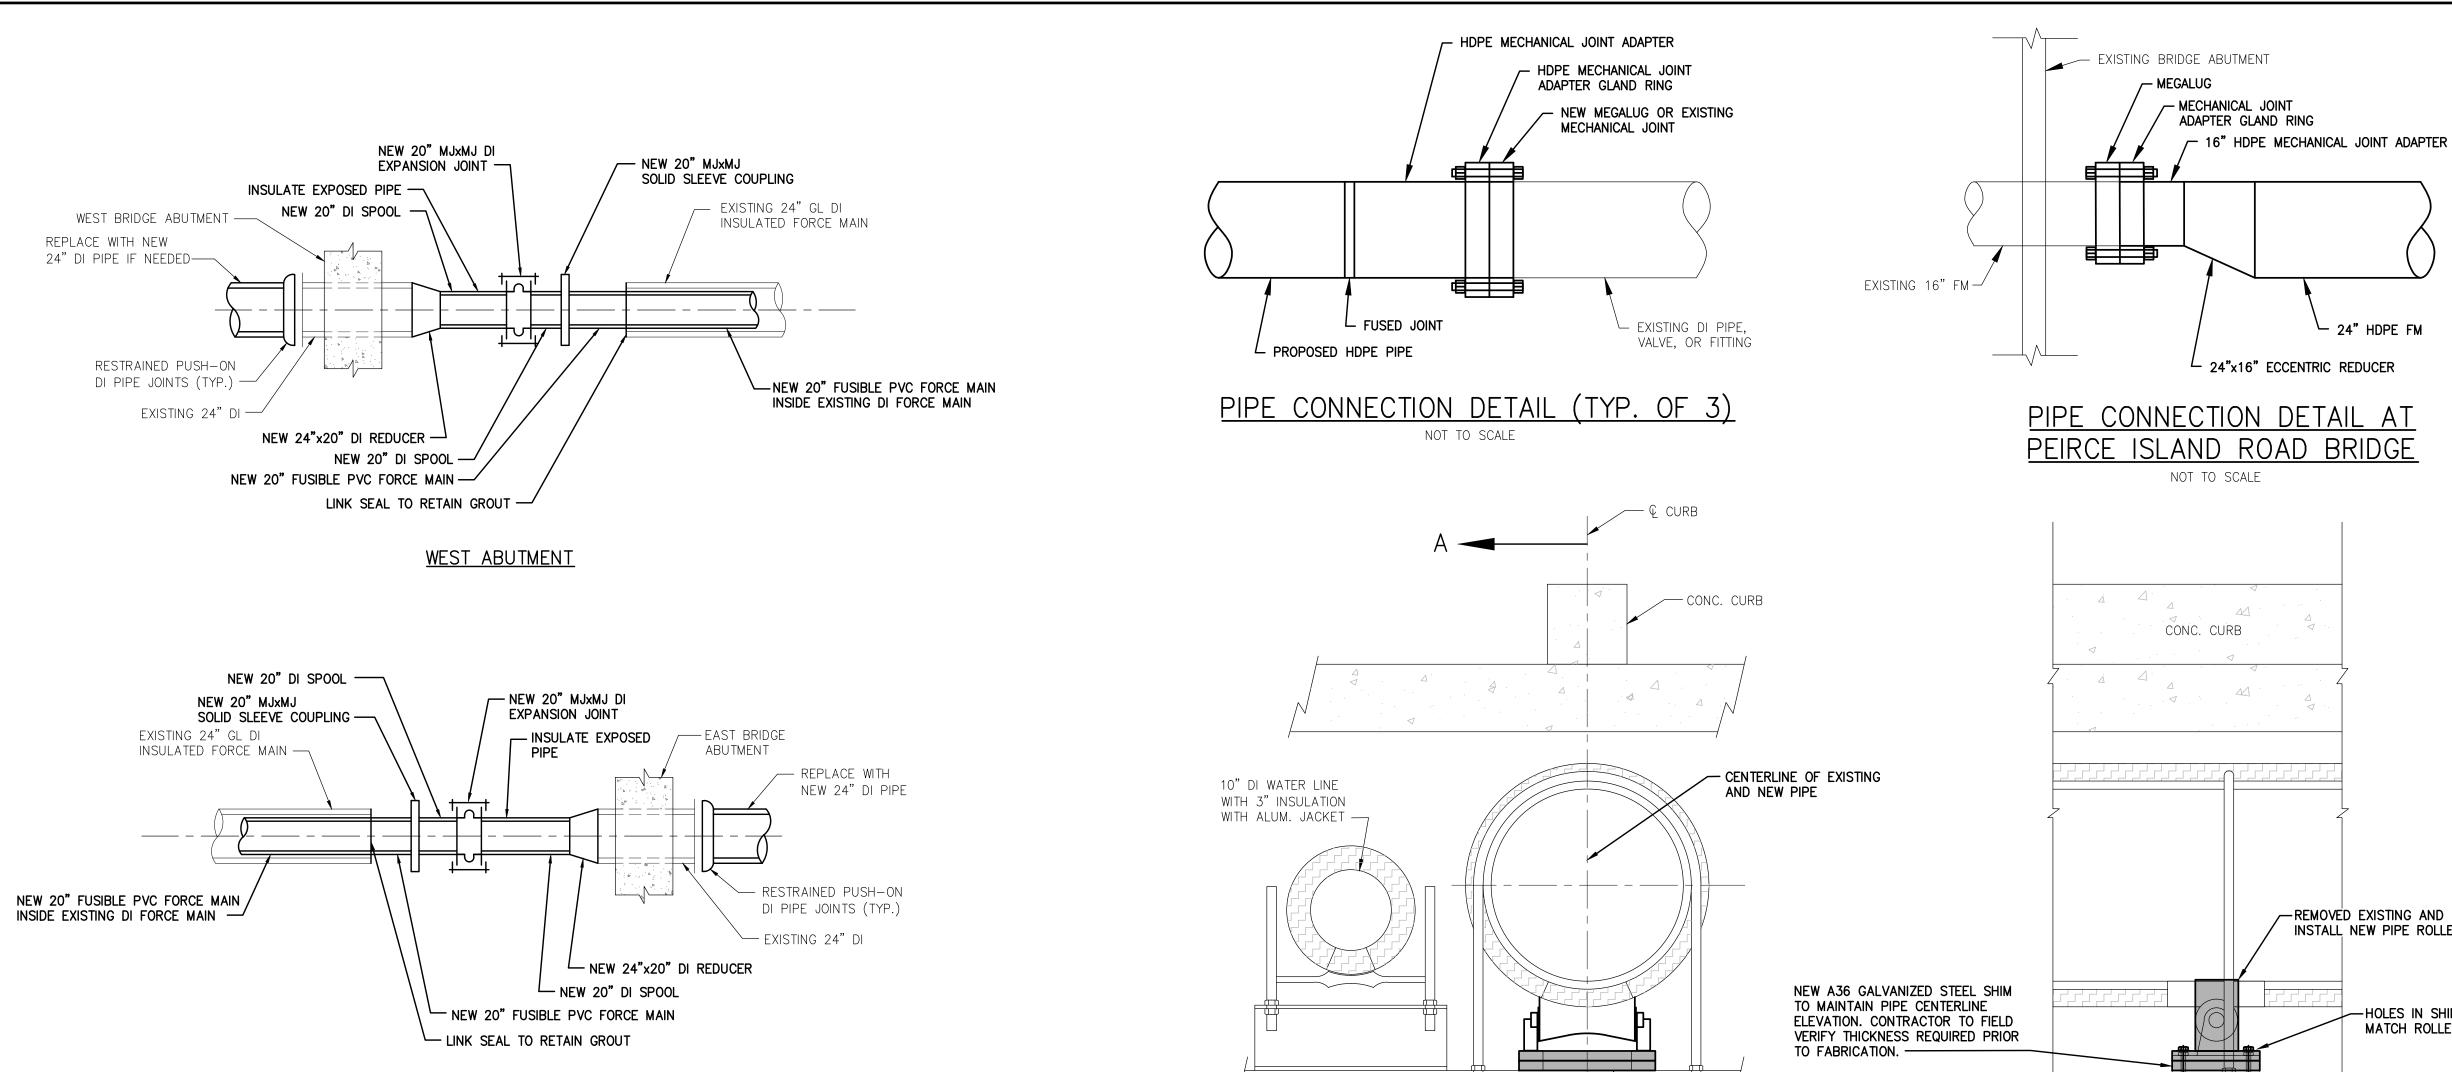


EAST ABUTMENT

NOTES:

- 1. ALL JOINTS TO BE RESTRAINED.
- 2. ALL FUSIBLE PVC JOINTS SHALL BE BUTT FUSED UNLESS INDICATED OTHERWISE.
- 3. FIELD VERIFY DIMENSIONS SO AS TO PROVIDE SUPPORT WHERE SHOWN ON THE PROFILE ON SHEET 00 C-110.

TRANSITION FROM FUSIBLE PVC TO DUCTILE IRON

NOT TO SCALE

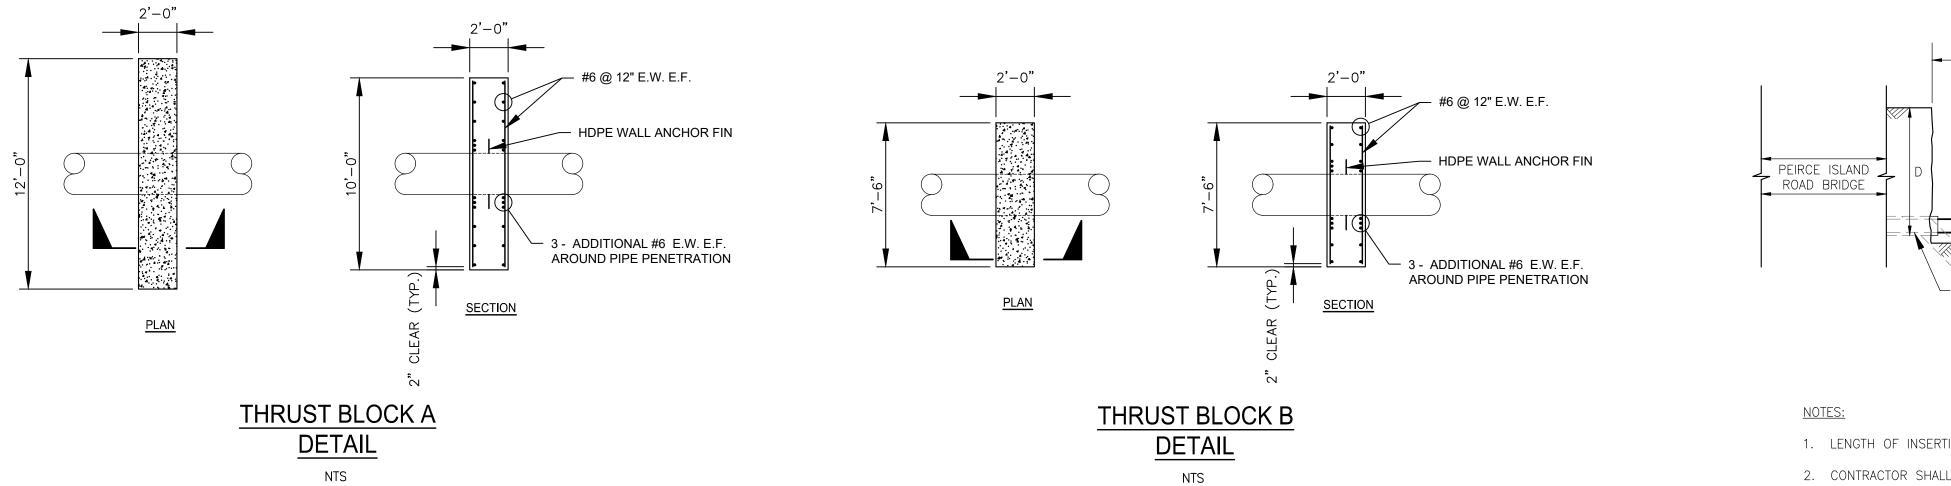

PIPE SUPPORT DETAIL (TYP. OF 4)


FIELD DRILL HOLES/OVERSIZE HOLES

NEW PIPE ROLLER BOLT SPACING —

IN EXISTING SHIM PLATE TO MATCH

NEW SHIM PLATE(S)

SECTION

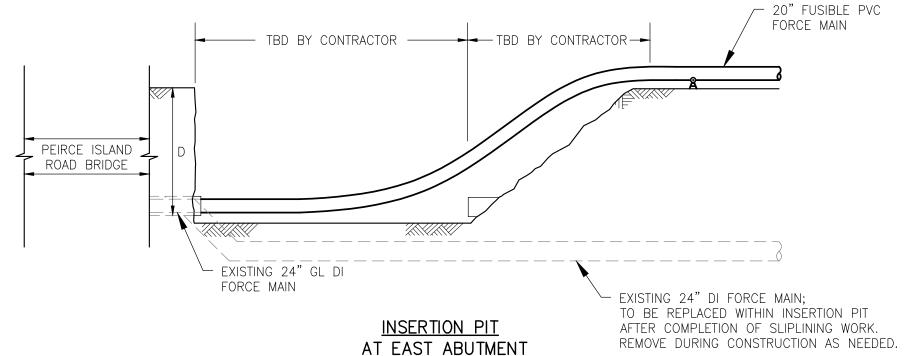

ELEVATION A-A

- 1. LENGTH OF INSERTION PIT AT EAST ABUTMENT IS DEPENDENT ON DEPTH (D) OF EXISTING FORCE MAIN.
- 2. CONTRACTOR SHALL DETERMINE LENGTH (L) OF ACCESS PIT AT WEST ABUTMENT TO ACCOMMODATE PULLING EQUIPMENT.

<u>SLIPLINING TRENCH SECTIONS - LONGITUDINAL</u>

AECOM

PROJECT

PEIRCE ISLAND FORCE MAIN AND WATER MAIN REPLACEMENT Peirce Island, Portsmouth NH

OWNER

24" HDPE FM

- REMOVED EXISTING AND INSTALL NEW PIPE ROLLER

-HOLES IN SHIM PLATE TO

MATCH ROLLER SPACING

-NEW (4) A-235 BOLTS, GALVANIZED,

DIAMÈTÉR TO SUIT HOLES IN NEW

PIPE ROLLER, DOUBLE NUT

CITY OF PORTSMOUTH **NEW HAMPSHIRE**

680 Peverly Hill Road Portsmouth, NH 03801

ENGINEER

AECOM TECHNICAL SERVICES, INC. 250 APOLLO DRIVE CHELMSFORD, MA 01824 PHONE: (978) 905-2100 www.aecom.com

REGISTRATION



ISSUE/REVISION

I/R DATE DESCRIPTION

PROJECT NUMBER

60649477


S. HE
M. THIBODEAU
C. BENZIGER
E. MESERVE
AUGUST 2021
AS NOTED

DISCIPLINE

CIVIL SHEET TITLE

DETAILS V

SHEET NUMBER

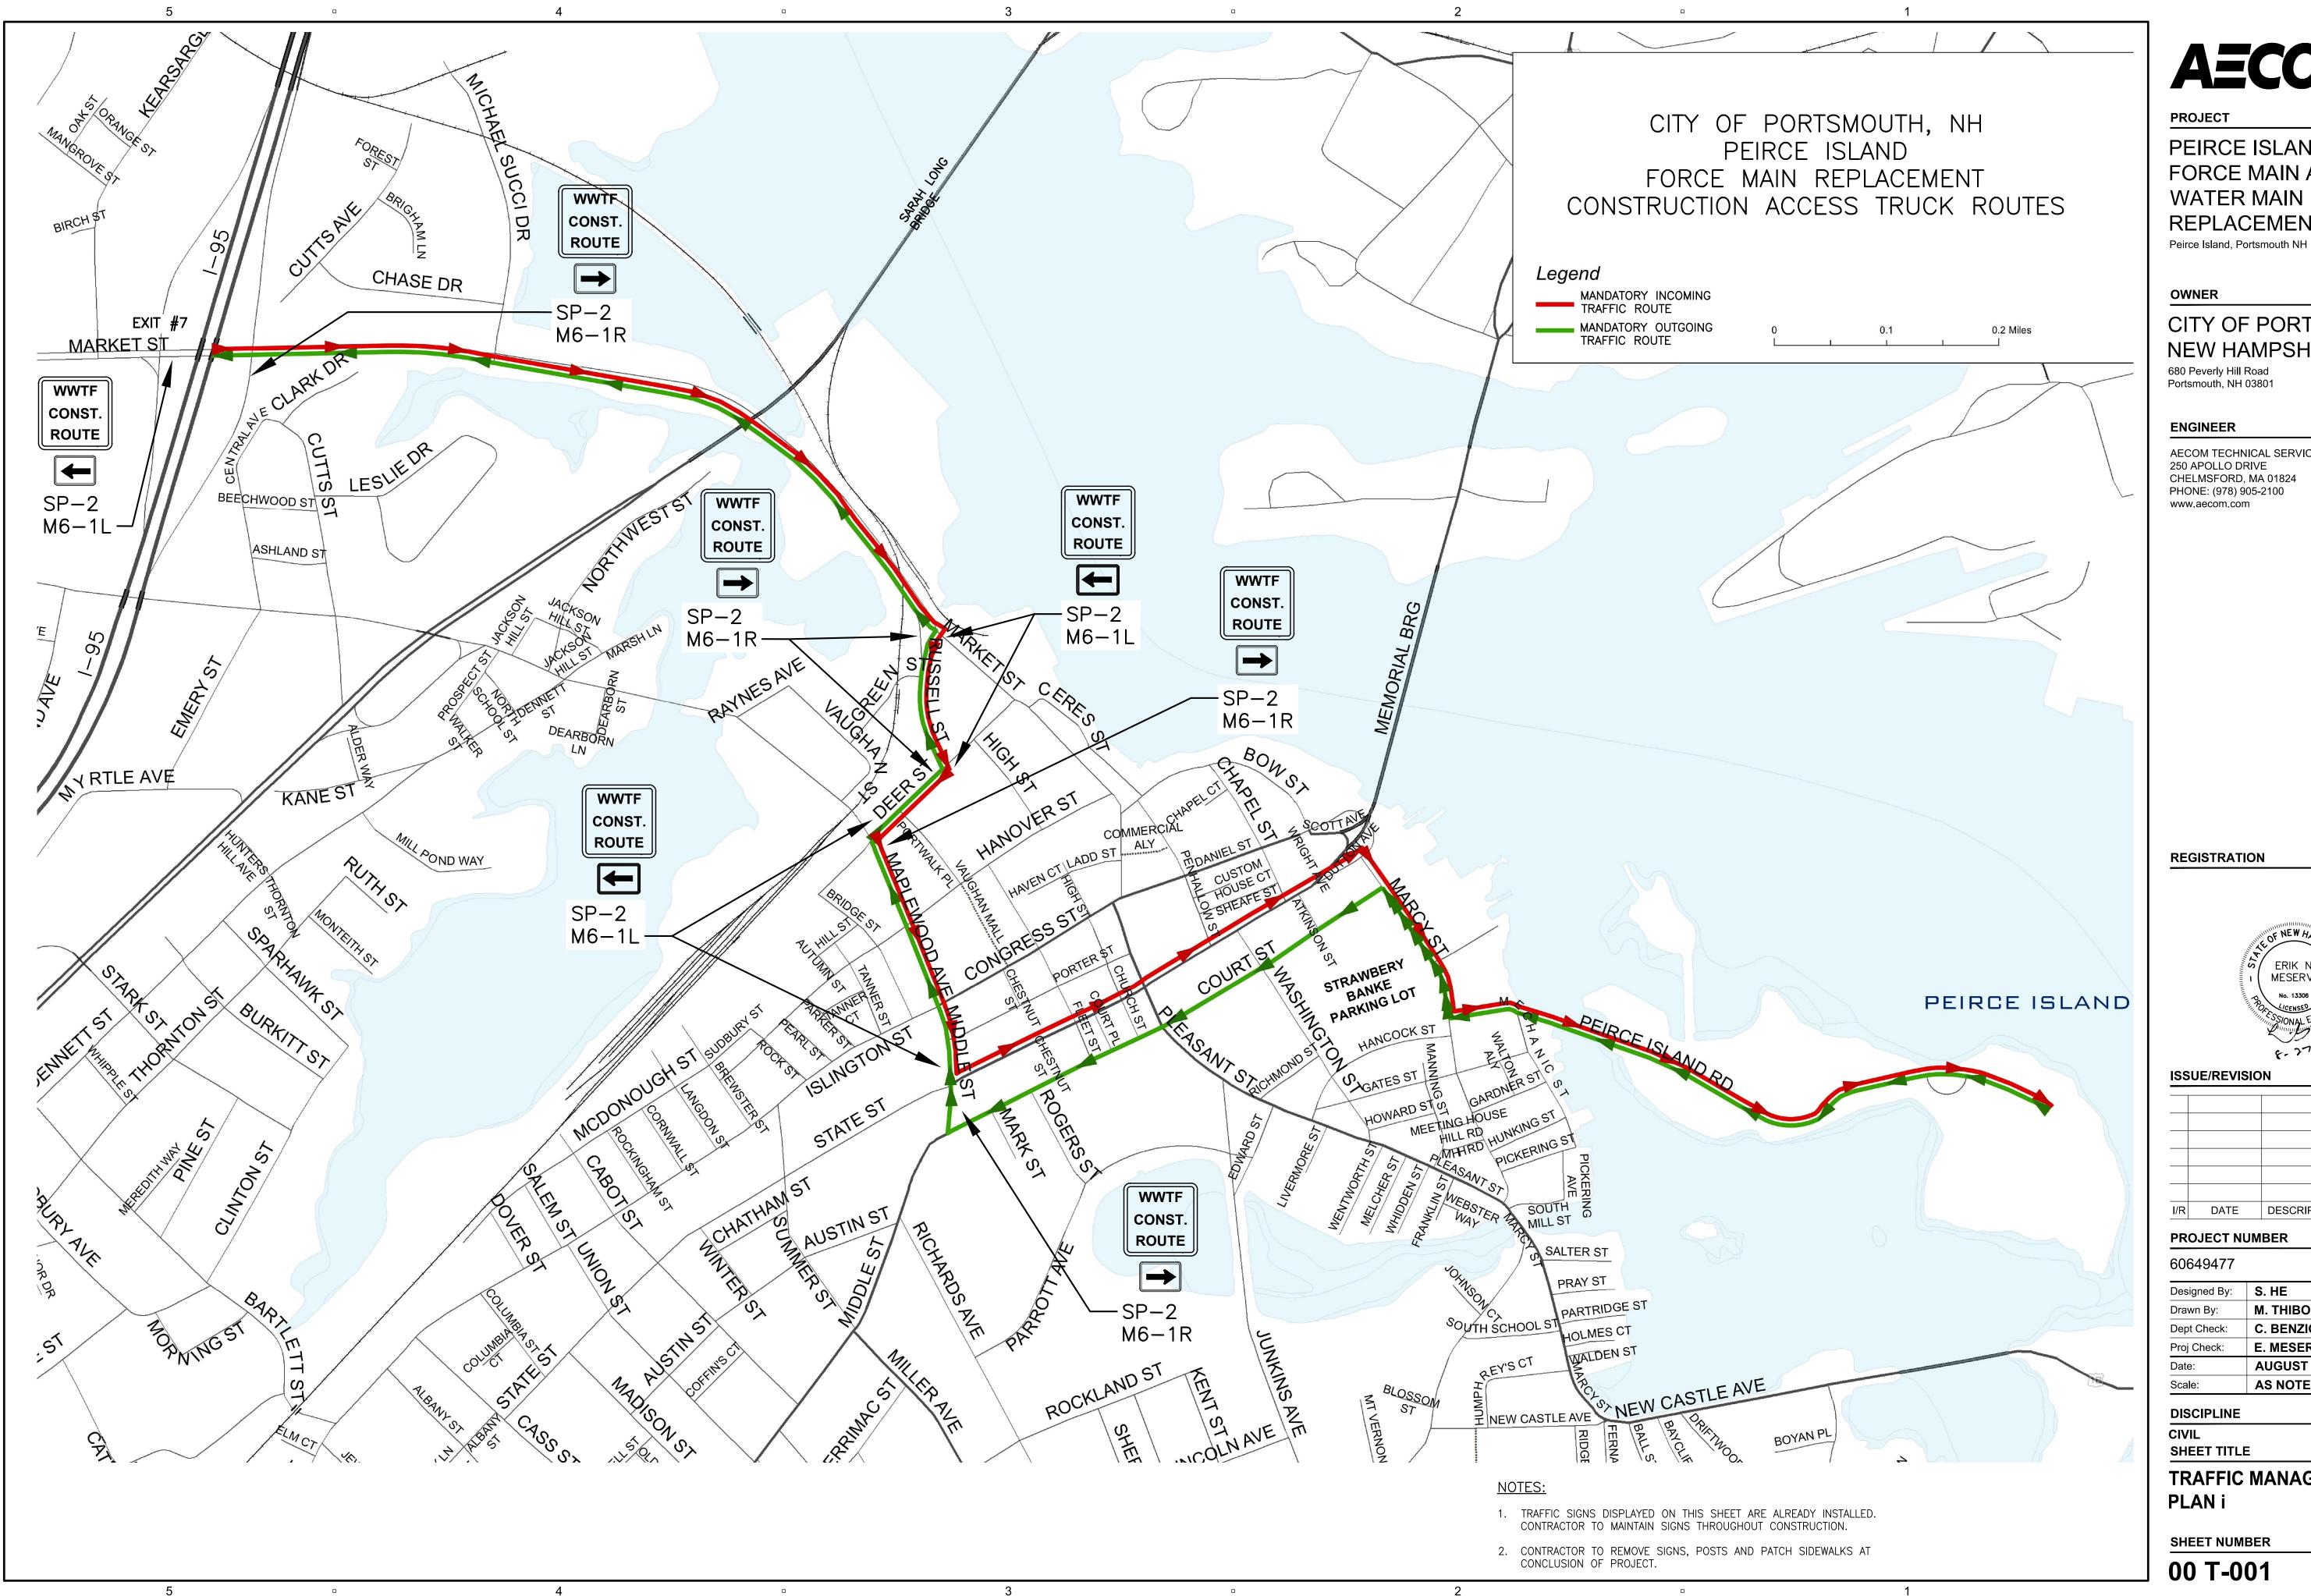

PROJECT

PEIRCE ISLAND FORCE MAIN AND WATER MAIN REPLACEMENT

CITY OF PORTSMOUTH **NEW HAMPSHIRE**

680 Peverly Hill Road Portsmouth, NH 03801

ENGINEER

AECOM TECHNICAL SERVICES, INC. 250 APOLLO DRIVE CHELMSFORD, MA 01824 PHONE: (978) 905-2100 www.aecom.com

REGISTRATION



ISSUE/REVISION

I/R	DATE	DESCRIPTION

PROJECT NUMBER

60649477

Designed By:	S. HE
Drawn By:	M. THIBODEAU
Dept Check:	C. BENZIGER
Proj Check:	E. MESERVE
Date:	AUGUST 2021
Scale:	AS NOTED


DISCIPLINE

SHEET TITLE

TRAFFIC MANAGEMENT **PLAN** i

SHEET NUMBER

00 T-001

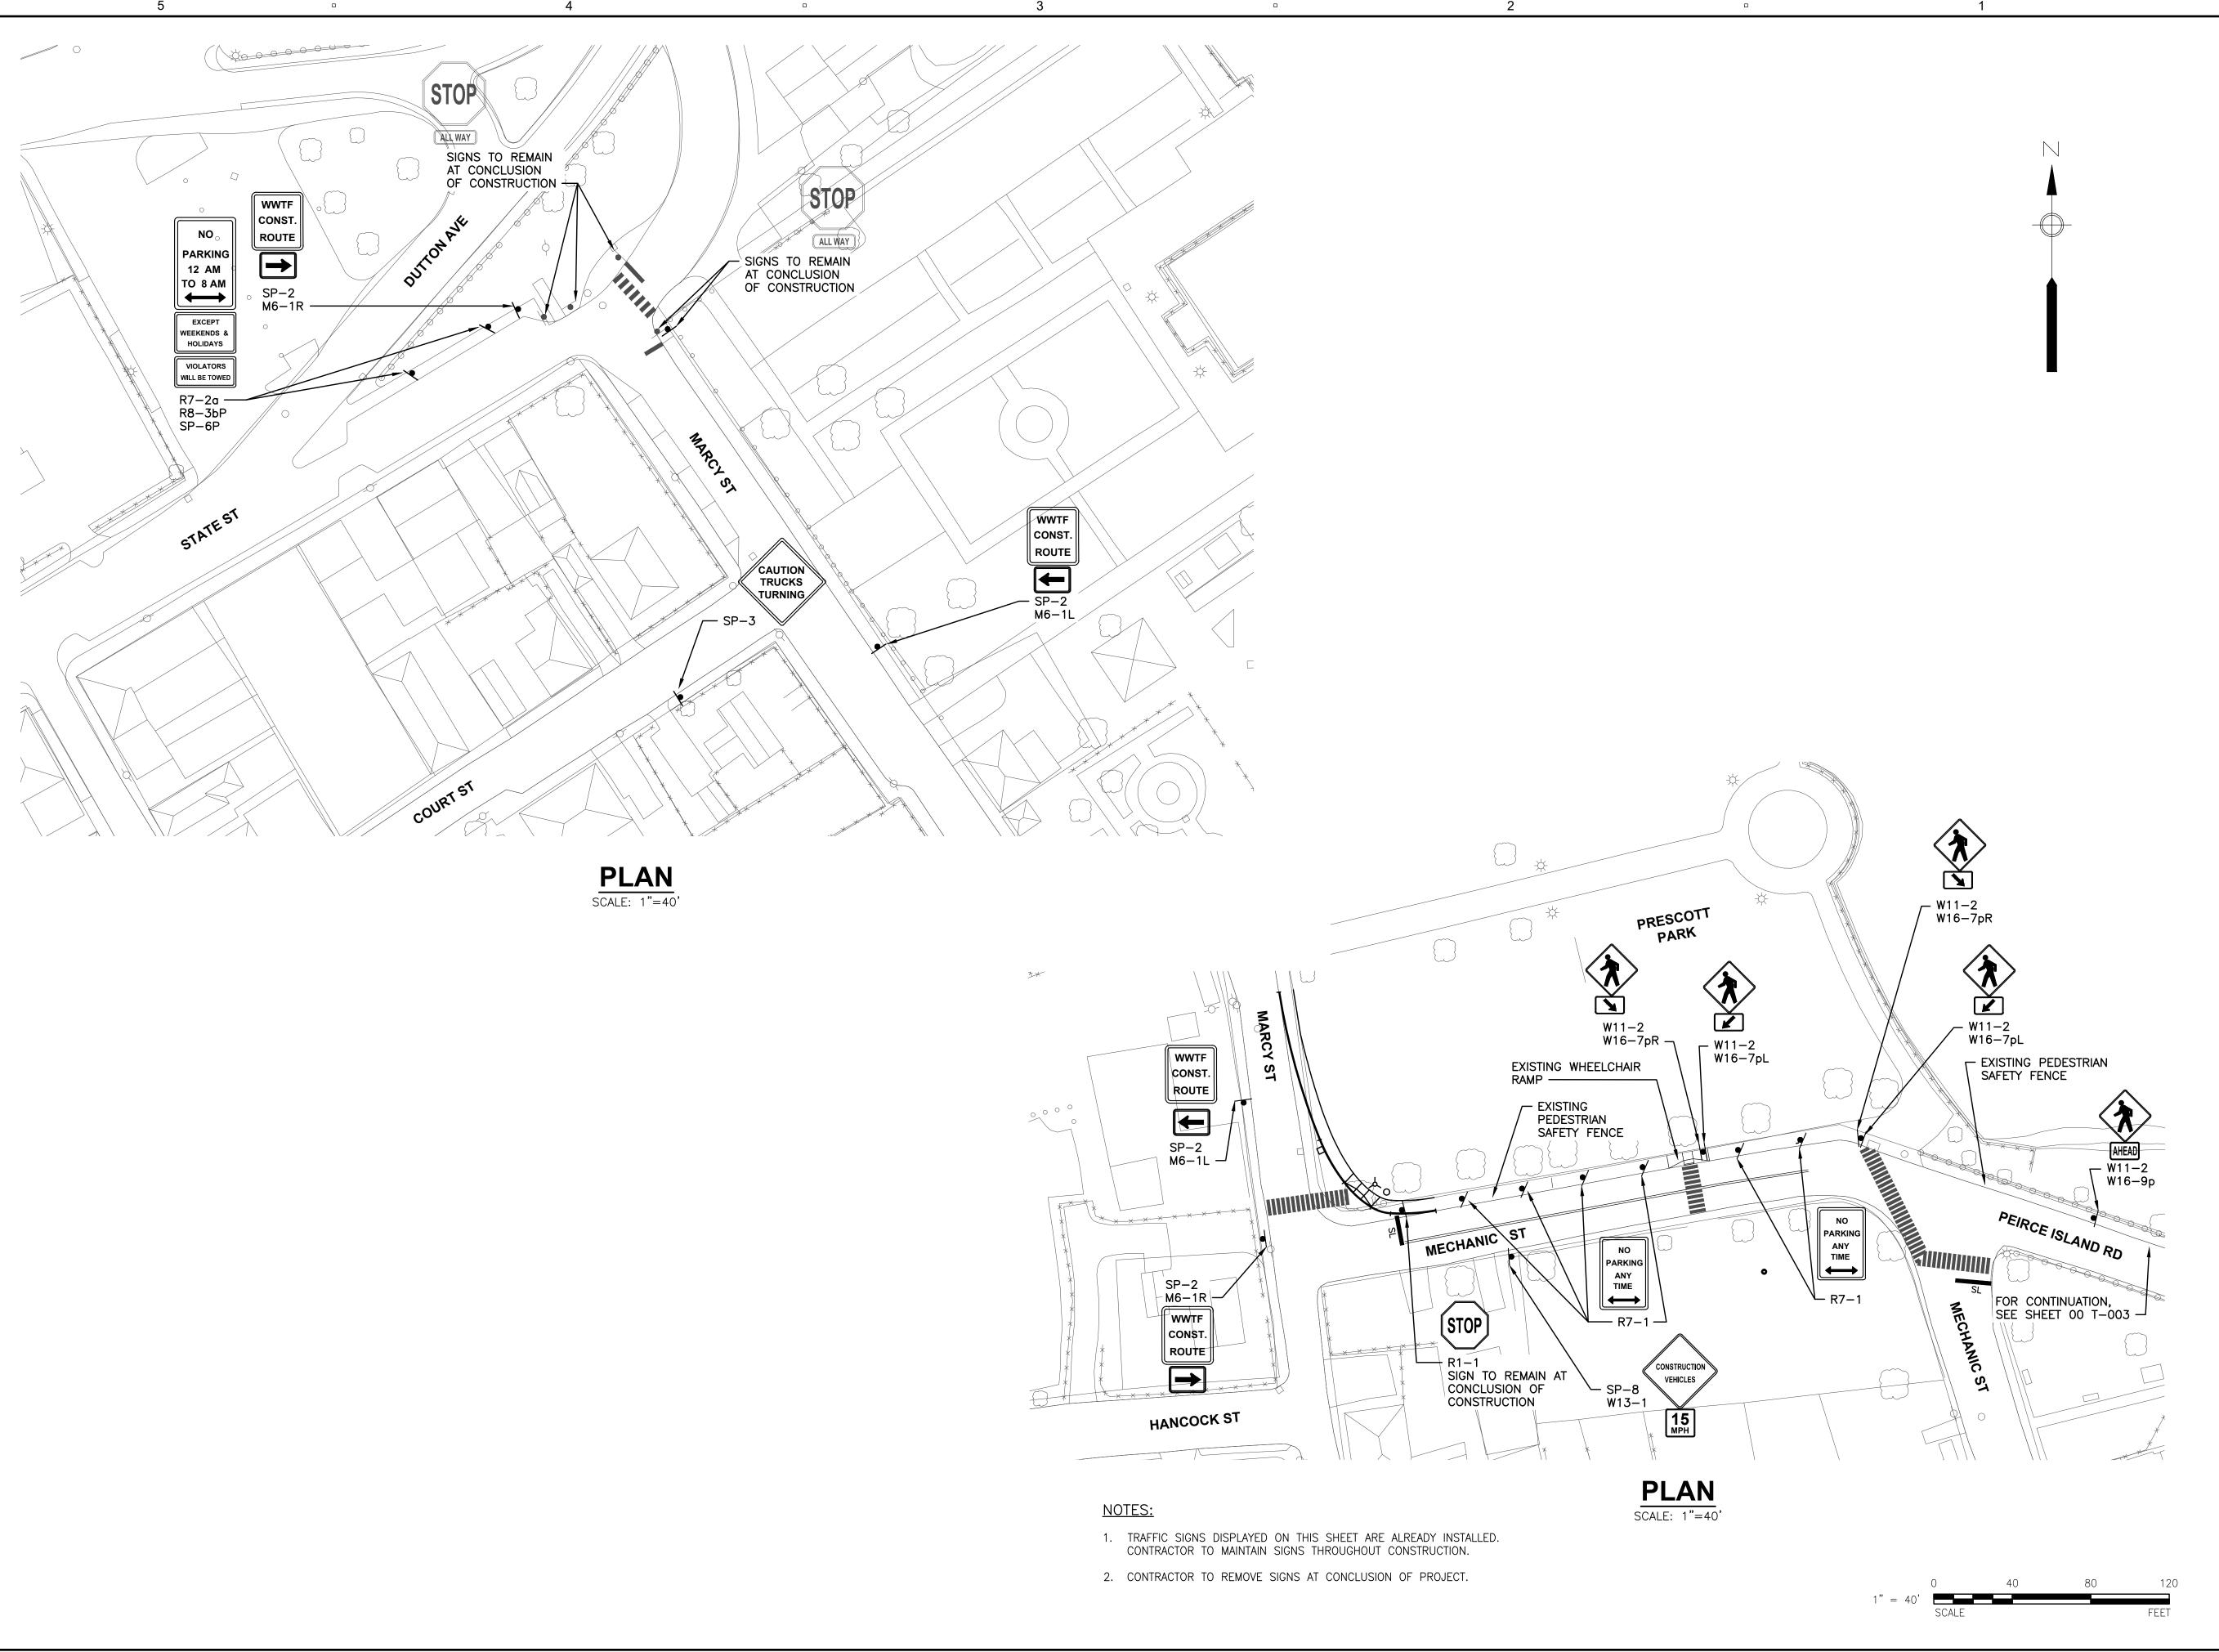

PROJECT

PEIRCE ISLAND
FORCE MAIN AND
WATER MAIN
REPLACEMENT
Peirce Island, Portsmouth NH

OWNER

CITY OF PORTSMOUTH NEW HAMPSHIRE

680 Peverly Hill Road Portsmouth, NH 03801

ENGINEER

AECOM TECHNICAL SERVICES, INC. 250 APOLLO DRIVE CHELMSFORD, MA 01824 PHONE: (978) 905-2100 www.aecom.com

REGISTRATION



ISSUE/REVISION

I/R	DATE	DESCRIPTION

PROJECT NUMBER

60649477

Designed By:	S. HE
Drawn By:	M. THIBODEAU
Dept Check:	C. BENZIGER
Proj Check:	E. MESERVE
Date:	AUGUST 2021
Scale:	AS NOTED


DISCIPLINE

CIVIL SHEET TITLE

TRAFFIC MANAGEMENT PLAN II

SHEET NUMBER

00 T-002

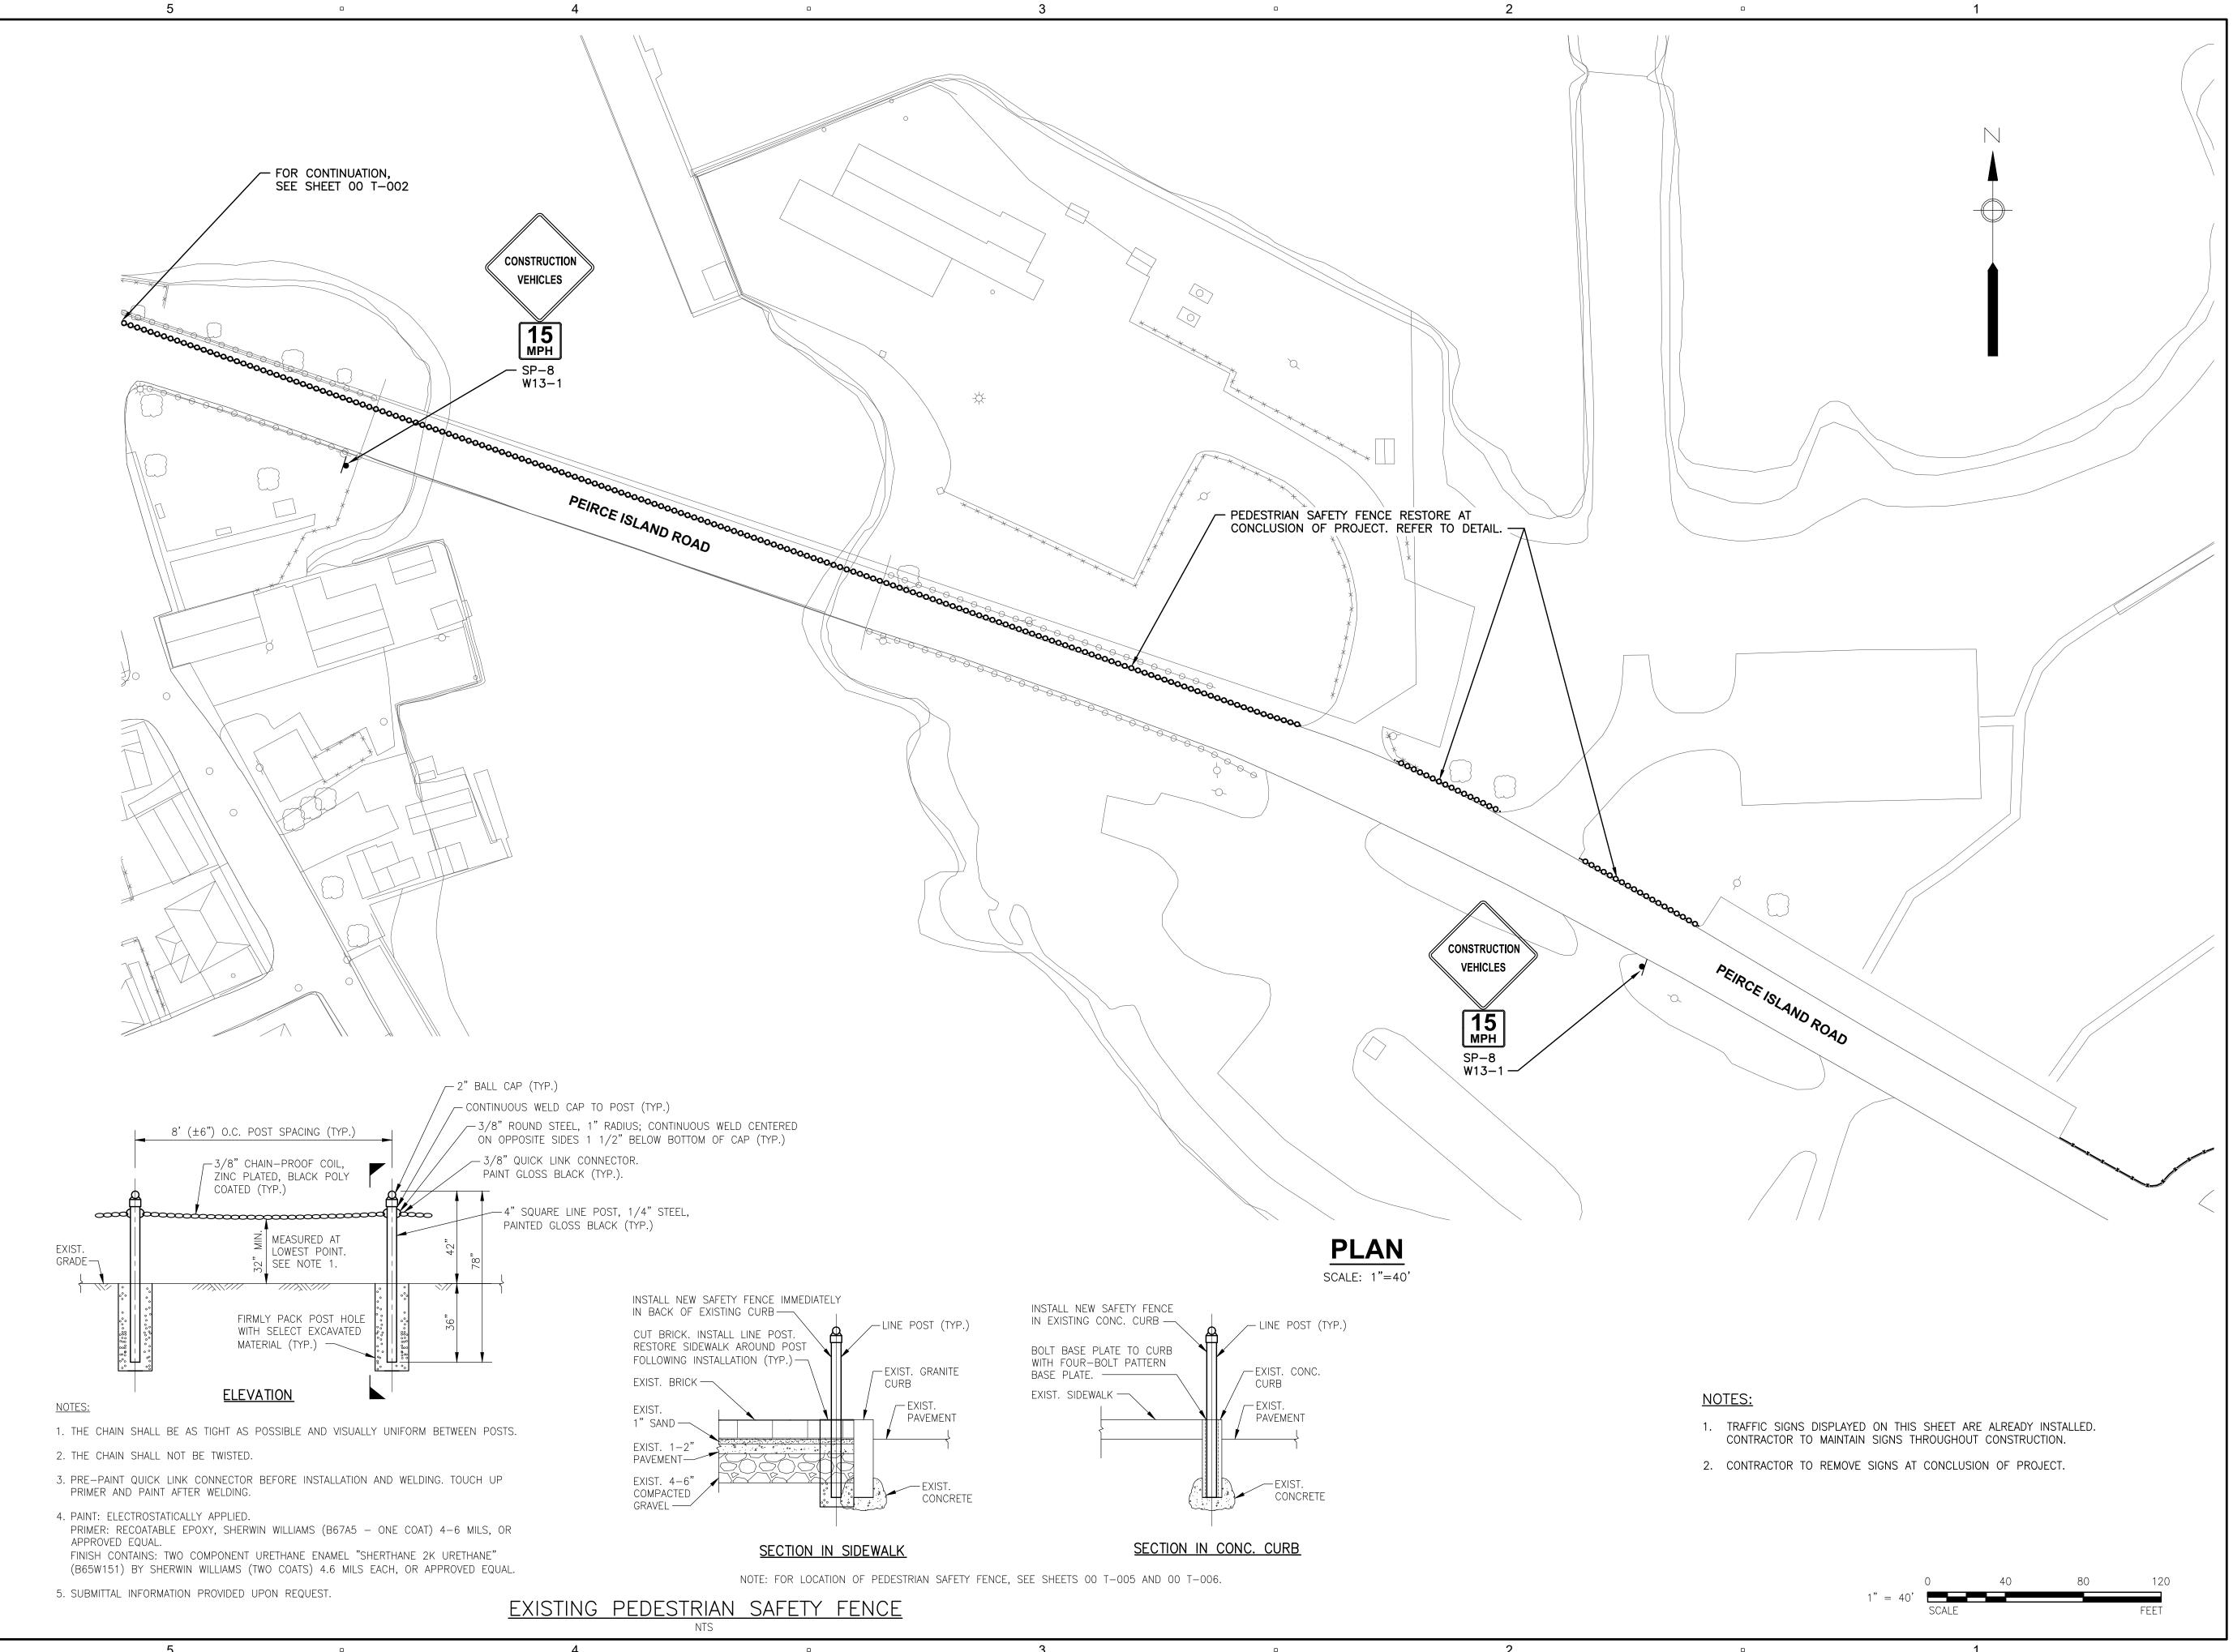

PROJECT

PEIRCE ISLAND FORCE MAIN AND WATER MAIN REPLACEMENT

Peirce Island, Portsmouth NH

OWNER

CITY OF PORTSMOUTH NEW HAMPSHIRE

680 Peverly Hill Road Portsmouth, NH 03801

ENGINEER

AECOM TECHNICAL SERVICES, INC. 250 APOLLO DRIVE CHELMSFORD, MA 01824 PHONE: (978) 905-2100 www.aecom.com

REGISTRATION



ISSUE/REVISION

I/R	DATE	DESCRIPTION
		•

PROJECT NUMBER

60649477

Designed By:	S. HE
Drawn By:	M. THIBODEAU
Dept Check:	C. BENZIGER
Proj Check:	E. MESERVE
Date:	AUGUST 2021
Scale:	AS NOTED

DISCIPLINE

CIVIL SHEET TITLE

TRAFFIC MANAGEMENT PLAN III

SHEET NUMBER

00 T-003